SOMA STAGE 3 - CHILDCARE CENTRE 8 GREGORY HILLS DR, GLEDSWOOD HILLS

DEVELOPMENT APPLICATION

PROPOSED CHILDCARE CENTRE & SIGNAGE

A000 R Cover Sheet A001 R Notes & Schedules A002 R Existing Conditions A005 R Existing Conditions A006 R Demolition Plan A050 R Site Plan A100 R Ground Floor Plan A101 R First Floor Plan A200 R Elevations A201 R Elevations A300 R Sections A301 R Sections A700 R Materials Schedule A800 R Solar Diagrams - 9am A801 R Solar Diagrams - 12pm A802 R Solar Diagrams - 3pm A850 R Ventilation Diagrams A860 R Bin Path Plans A870 R Egress Path Plans A880 R Boundary Fence Detail A900 R Perspectives



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Check all dimensions and site conditions prior to the commencement of any work, the purchase or	Rev	Description	Date	Soma Stage 3 - 0	Childcare Cen	itre	
ordering of any materials, fittings, plant, services or equipment and the preparation of shop drawings and	K Co	oncept Design	31.03.2023	9 Gregory Hills Dr, Gled	swood Hills		
/ or the fabrication of any components.		sued for Pre-DA	20.04.2023	Cover Sheet		STATUS	Development Application
Do not scale drawings - refer to figured dimensions		sued for review	28.06.2023			DRAWN BY	BR
only. Any discrepancies shall immediately be referred	O Dr	raft DA for Review	24.07.2023				DR
to the architect for clarification.	P Re	evised Draft DA	01.08.2023	Soma		SCALE	
	Q Iss	sued for DA	22.08.2023	PROJECT NUMBER	2023-0170	REVISION R	
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AUGUST 2023 **REVISED DECEMBER 2023**

FITOUT NOTES

FITOUT TO COMPLY WITH THE FOLLOWING ACTS & CODES

THE WALLS FLOORS AND CEILING CONSTRUCTION INCLUDING FINISHES AND FITOUT OF ROOMS USED FOR FOOD PREPARATION, STORAGE OR DISPLAY SHALL COMPLY WITH THE REQUIREMENTS OF THE FOOD REGULATION 2004 UNDER THE FOOD ACT 2003, STANDARD 3.2.3 – FOOD PREMISES AND EQUIPMENT OF THE AUSTRALIA NEW ZEALAND FOOD STANDARDS CODE, AUSTRALIAN STANDARDS AS4674-2004 "DESIGN, CONSTRUCTION AND FITOUT OF FOOD PREMISES", AND LOCAL COUNCIL POLICIES.

THE WALLS INCLUDING INTERNAL WALLS OF THE FOOD PREMISES TO THE FOOD PERPARTION AREAS, KTICHENS, SCULLERIES, FOOD DISPLAYS, FOOD SERVERIES AND FOOD STORAGE AREAS SHALL BE OF SOLID CONSTRUCTION (EG BRICK, CONCRETE, BLOCKWORK, LIGHT WEIGHT CONCRETE BLOCK OR OTHER SIMILAR APPROVED HOMOGENOUS MATERIAL.

AY KTICHENS, SCULLERIES, FOOD DISPLAYS, FOOD SERVERIES AND THE LIKE SHALL BE FINISHED TO A HEIGHT OF AT LEAST TWO (2) METRES ABOVE FINISHED FLOOR LEVEL WITH: -(I) GLAZED TILES FIXED IN ACORRDANCE WITH THE

REQUIREMENTS OF AS3958.1; (II)STAINLESS STEEL OR OTHER APPROVED IMPERVIOUS

MATERIAL ADHERED DIRECTLY TO THE WALL

CEILINGS OVER FOOD PREPARATION DISPLAY AND STORAGE AREAS ARE TO BE CONSTRUCTED OF RIGID SMOOTH FACED MATERIAL SUCH AS PLASTERBOARD OR VILLABOARD FINISHED WITH SET JOINTS AND PLASTER CORNICE AT THE WALLS AND ARE REQUIRED TO BE PAINED IN A WASHABLE GLOSS PAINT OF LIGHT COLOUR.

FLOORS ARE TO BE COVERED IN APPROVED FLOOR COVERINGS; (A) WITH THE USE OF CERAMIC FLOOR TILES COVED WITH A 25MM

CERAMIC COVE TILE AT THE INTERSECTION OF WALLS, OR (B) WITH THE USE OF A CONTINUOUS SHEET VINYL RETUTEDN 150MM UP THE WALL TO FORM A COVE AND SEALED TO THE WALL AND FILLET WITH AN APPROVED FILLET OR BACKING PIECE TO PROVIDE SUPPORT, OR (C) WITH THE USE OF CHEMICAL TO PROVIDE SUPPORT, OR (C) WITH THE SUPPORT, OR (C) WITH THE SUPPORT OF CHEMICAL TO PROVIDE SUPPORT, OR (C) WITH THE SUPPORT OF CHEMICAL TO PROVIDE SUPPORT OF CHEMICAL TO PROVE OF CHEMICAL TO PROVIDE S (C) WITH THE USE OF IMPERVIOUS TROWELLED EPOXY OVER CONCRETE, COVED AT THE INTERSECTION OF THE WALLS AND FLOOR

FLOORS ARE TO BE ADEQUATELY GRADED AND DRAINED TO THE REQUIRED FLOORWASTE(S)

LIGHT FITTINGS BEING RECESSED FLUSH TO THE CEILING SURFACE OR BE OF A "SQUARELINE"TYPE ATTACHED TO THE UNDERSIDE AND PROVIDED WITH APPROVED DIFFUSER COVER.

SERVICES PIPES. CONDUITS. CONDENSATE DRAINS AND THE LIKE BEING CONCELAED BEHIND THE FINISHED FLOOR AND CEILING SURFACES. WHERE SUCH SERVICES ARE INSTALLED PRE-FABRICATED PANELS PROVIDE 25MM CLEARANCE OFF PANEL SURFACES.

ALL HOT AND COLD HOLDING UNITS USED FOR STORAGE OR PERISHABLE FOODS EG COOLROOM/FREEZER ROOMS, FRIDGES, PIE WARMERS, BAIN MARIES, ROLLER GRILLS, ETC MUST BE FITTED WITH PERMANENT THERMONETERS ACURATE TO ONE (1) DECREE THAT ARE ABLE TO BE READ OUTSIDE THE UNIT (IE WITHOUT OPENING THE UNIT) AND MUST BE FITTED IN A LOCATION THAT GIVES AN ACCURATE READING OF THE TEMPERATURE OF THE FOOD.

ALL COOKERS, OVENS, VATS, FRIDGES, FREEZERS, BENCHES, CUPBOARDS, SHELVES OR SIMILAR APPLIANCES OR EQUIPMENT ARE ERQUIRED TO BE FITTED WITH LEGS SO AS THE BASE IF THE UNIT US AT LEAST 150MM OFF THE FLOOR SURFAC. FURTHER CONSIDERATION MUST BE GIVEN TO DEEP UNITS SO AS TO NOT HINDER CLEANING REQUIREMENTS.

WASTE DRAINAGE FROM THE COFFEE MACHINE SHALL BE CONVEYED TO THE SEWER BY APPROVED CLEANING MEANS. IT IS THE APPLICANTS RESPONSIBILITY TO ENSURE THAT THE APPROPRIATE PROGRESS AND FINAL INSPECTIONS OF THE FOOD PREMISES FITOUT HAVE BEEN CARRIED OUT BY THE PRINCIPAL CERTIFYING AUTHORITY

A CLEANERS SINK SHALL BE PROVIDED WITH HOT AND COLD WATER CONNEDTED THERE TO THROUGH COMMON MIXING SPOUT. THIS WILL BE LOCATED IN THE STORAGEE ROOM NEXT TO THE EMPLOYEE AMENITIES. REFER TO PLANS FOR LOCATION.

ALL HAND WASH BASINS SHALL BE PROVIDED IN SUFFICIENT NUMBER WITHIN A FOOD PREMISES AND MUST BE FITTED WITH A "HANDS FREE" OPERATION WITH A SINLGE SPOUT TO MIX HOT AND COLD WATER

ALL WALL, FLOOR AND CEILING PENETRATIONS TO BE SEALED TO PREVENT VERMIN/ PEST ACCESS

ALL SERVICE PIPES & CONDUITS TO BE LABELLED PER AS1345 & AS1319. ALL WATER SUPPLY TO BE PROVIDED PER AS3500.1.2 & AS3500.4.2

VENITLATION (BOTH NATURAL & MECHANICAL) TO BE PROVIDED PER BCA REQUIREMENTS

LIGHT FITTINGS PROVIDED PER BCA & AS4674-2004

ALL TILES IN FOOD PREPARATION AND WASHING AREAS TO BE EPOXY GROUTED AND WALL/FLOOR JUNCTION COVING TO BE PROVIDED PER AS4674-2004 REQS

UNDERSIDE OF ALL COUNTERS IN FOOD/BEVERAGE PREPARATION AND WASHING AREAS TO BE IMPERVIOU

ALL SLIDING JOINERY DOORS TO BE TOP HUNG. NO BACK PANEL TO BE PROVIDED TO JOINY CUPBOARDS TO ALLOW INSPECTION BEHIND

KITCHEN EQUIPMENT INSTALLED PER AS4674-2004, SUCH THAT IT IS EASILY MOVEABLE, SEALED TO THE WALL OR SET OFF THE WALL TO ALLOW FOR INSPECTION AND CLEANING

GARBAGE STOREROOMS TO COMPLY WITH AS4674 AND INCLUDE THE

FOLLOWING; A) TO BE GRADED AND DRAINED TO SEWER,

B) PAVED WITH IMPERVIOUS MATERIAL C) PROVIDED WITH A HOSE TAP CONNECTION TO THE WATER SUPPLY, BE D) VENTILATED, PROOFED AGAINST PESTS E) COVING PROVIDED TO WALL AND FLOOR INTERSECTIONS.

GARAGE STOREROOMS ROOM TO COMPLY WITH AS4674.

FLOOR FINISH TO BE IMPERVIOUS, GRADED AND DRAINED TO SEWER WITH COVING AT WALL JUNCTIONS. HOSE TAP CONNECTED TO WATER SUPPLY TO BE PROVIDED WITHIN THE ROOM ROOM TO BE VENITALTED AND PROOFED AGAINST PESTS.

CARPARKING

ALL PARKING SPACES TO COMPLY WITH AS2890.1 AND BUILDING CODE REQUIREMENTS

ACCESSIBLE REQUIREMENTS

ALL ACCESSIBLE BATHROOMS TO COMPLY WITH AS1428.1 AND BUILDING CODE REQUIREMENTS BUILDING ACCESS TO COMPLY WITH AS1428.1 AND BUILDING CODE

CHILDCARE FACILITIES

CHILDCARE FACILITIES TO COMPLY WITH BUILDING CODE AND NATIONAL QUALITY STANDARDS AS REQUIRED

DEVELOPMENT REQUIREMENTS

CHILDCARE

UNENCUMBERED PLASPACE REQUIREMENTS INTERNAL - 3.25sqm PER CHILD EXTERNAL - 7sqm PER CHILD

PARKING REQUIREMENTS 1 SPACE PER 4 CHILDREN

1 MOTORBIKE PER 50 CARS **1 BICYCLE PER 25 CARS**

SETBACKS

- AS PER ADJACENT FRONT SIDE

- 1.2m - 4m IF DOORS TO INTERNAL PLAYSPACE FACE BDRY RFAR - 4m GROUND - 8m FIRST FLOOR

PARKING GENERALLY

- BUSINESS DEVELOPMENT AREA REQUIRES HRV ACCESS - 2.5m WIDE LANSCAPE BAY PER 8 CAR SPACES - 1m WIDE LANDSCAPE STRIP AT END/START OF EACH BAY - 1m WIDE LANDSCAPE STRIP ALONG BOUNDARY

DEVELOPMENT SUMMARY

SITE AREA - 3501sam

CHILDCARE

ROOM SUMMARY


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R#	AGE (yrs)	PLACES	STF/RAT	INTERNAL	EXTERNAL	store(int0.	2) s
01	0-2	16	4 @ 1:4	52sqm	112sqm	3.2sqm	4
02	0-2	16	4 @ 1:4	52sqm	112sqm	3.2sqm	4
03	2-3	25	5 @ 1:5	82sqm	175sqm	5sqm	7
04	2-3	25	5 @ 1:5	82sqm	175sqm	5sqm	7
05	2-3	25	5 @ 1:5	82sqm	175sqm	5sqm	7
06	3-5	30	3 @ 1:10	98sqm	210sqm	6sqm	g
07	3-5	30	3 @ 1:10	98sqm	210sqm	6sqm	ĝ
08	3-5	30	3 @ 1:10	98sqm	210sqm	6sqm	ç
TOTAL		197	32	644sqm	1,379sqm	39.4sqm	5

PARKING

CARS @ 1:4 CHILDREN = 50 CARS MOTOS @ 1:50 CARS = 1 MOTO BIKES @ 1:25 CARS = 2 BIKES

PARKING PROVIDED	- CARS - MOTORBIKE - BICYCLE	= 63 spaces (2 x Accessible) = 4 spaces = 8 spaces
LANDSCAPING	DEEP SOIL	- 415sqm (12%)
GFA	GFL FFL TOTAL FSR	- 140sqm - 1100sqm - 1540sqm - 0.44:1

	Rev	Description	Date			
	G	Revised Concept for Discussion	06.03.2023			
	н	Issued for Review	16.03.2023			
	1	Issued for Review	23.03.2023			
	J K	Prelim Concept Design Concept Design	29.03.2023 31.03.2023			
	L	Issued for Pre-DA	20.04.2023			
	N	Issued for review	28.06.2023			
	0	Draft DA for Review	24.07.2023			
	Р	Revised Draft DA	01.08.2023			
	Q R	Issued for DA Amended for DA	22.08.2023 08.12.2023			
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4.8sqm 7.5sqm 7.5sqm 7.5sqm	fabrica	e preparation of shop drawings tion of any components.				
9sqm 9sqm <u>9sqm</u> 59.1sqm	Do not scale drawings - refer to figured dimensions only. Any discrepancies shall immediately be referred to the architect for clarification.					
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	Soma Stage 3 - Childcare Centre					
	9 Gre	egory Hills Dr, Gledswoo	od Hills			
	Som	a				
	Note	s & Schedules				
	PRO	JECT NUMBER	2023-0170			
	DAT	E	August 2023			
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Rev	Description	Date			
F	Prelim Concept for review	01.03.2023			
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R	Amended for DA	08.12.2023			
(A) - RIGHT OF CARRIAGEWAY 6.2m WIDE (B) - RIGHT OF CARRIAGEWAY 3.5m WIDE (C) - RIGHT OF CARRIAGEWAY 6.6m WIDE					
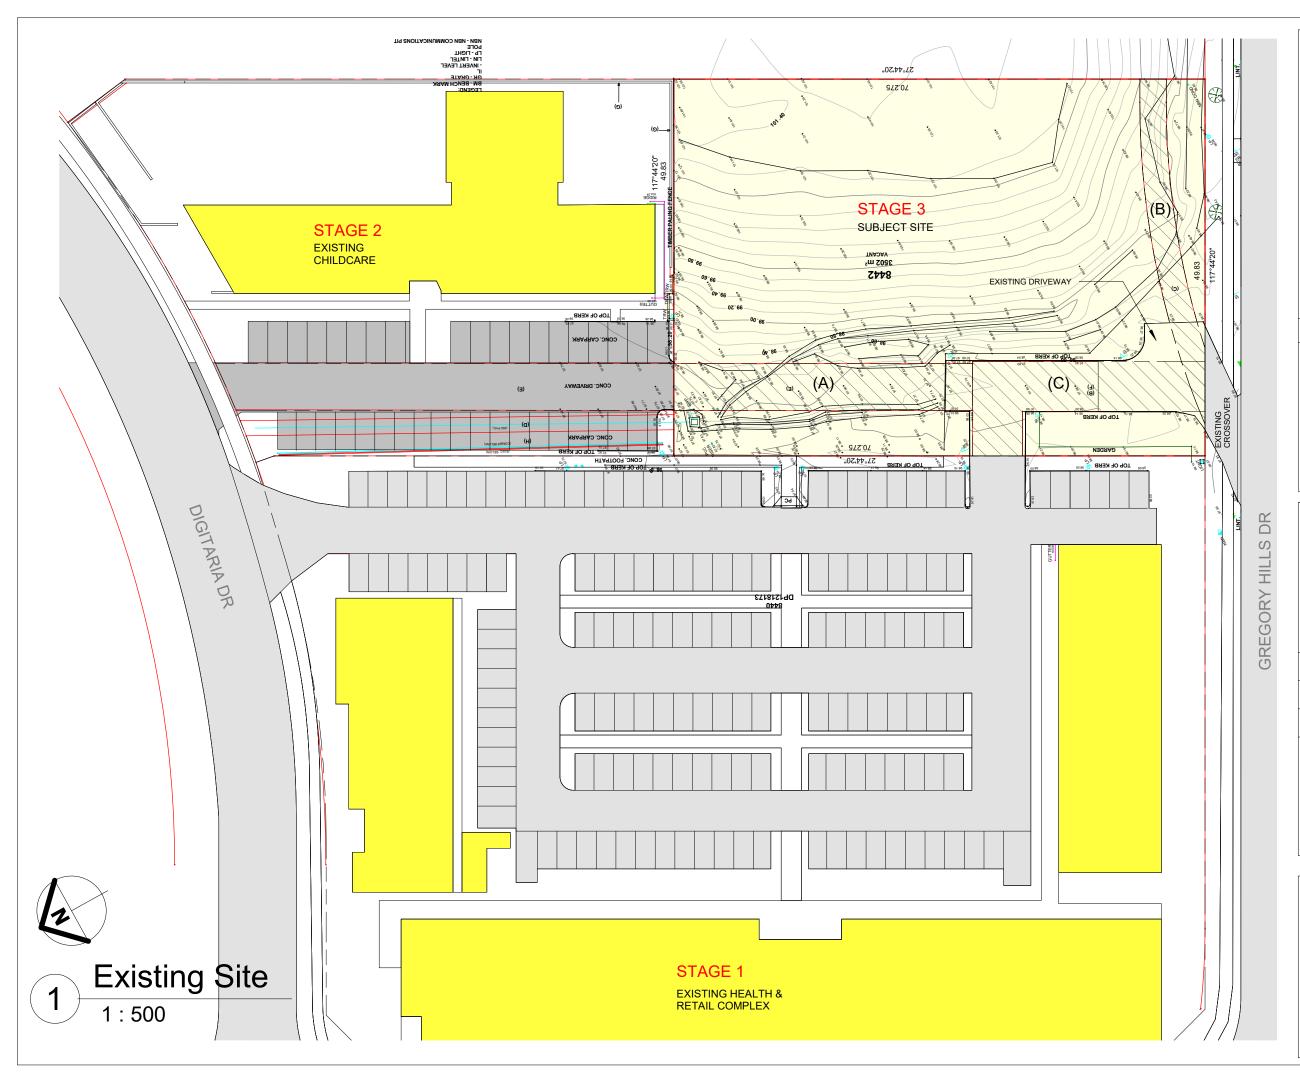
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Soma Stage 3 - Childcare Centre

9 Gregory Hills Dr, Gledswood Hills

Soma

Existing Conditions

PROJECT NUMBER

2023-0170

DATE

August 2023

STATUS

Development Application

DRAWN BY

BR

SCALE

DRAWING NO.


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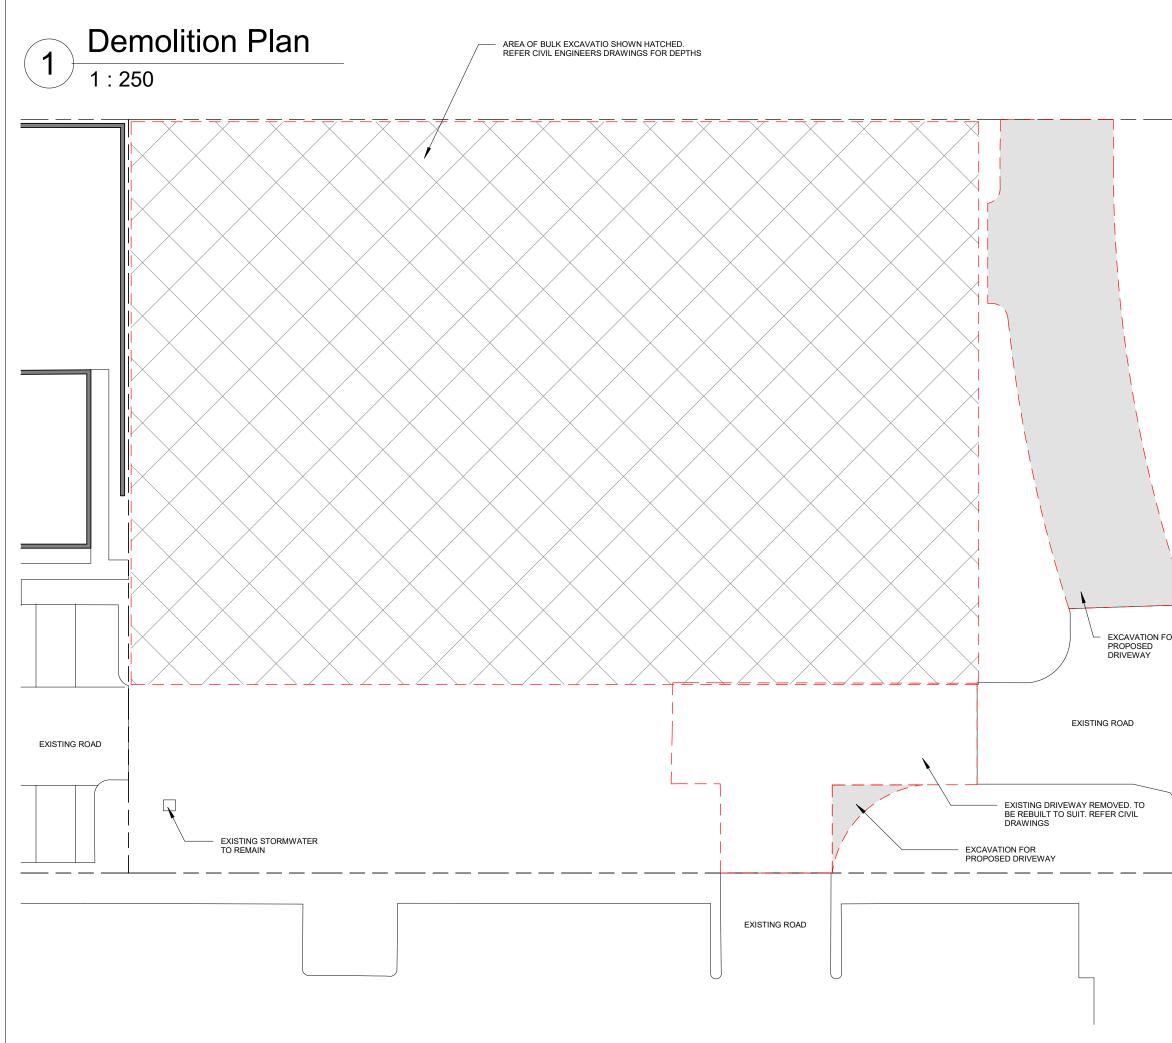
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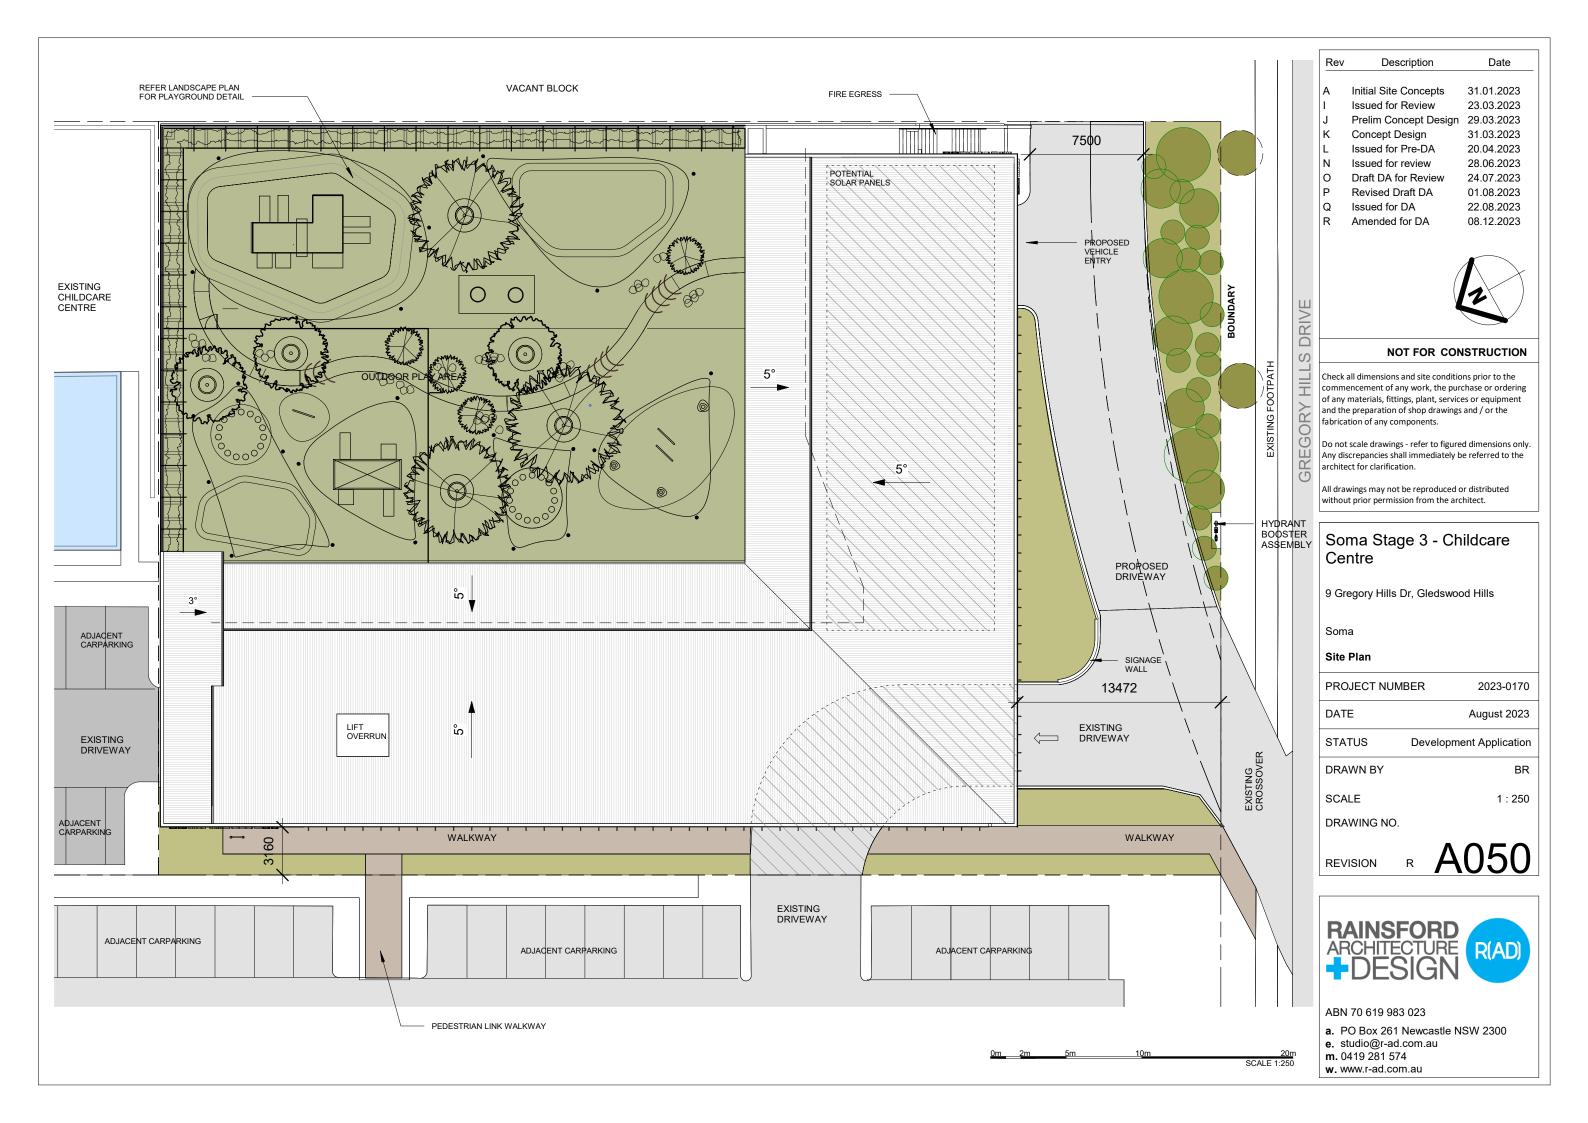


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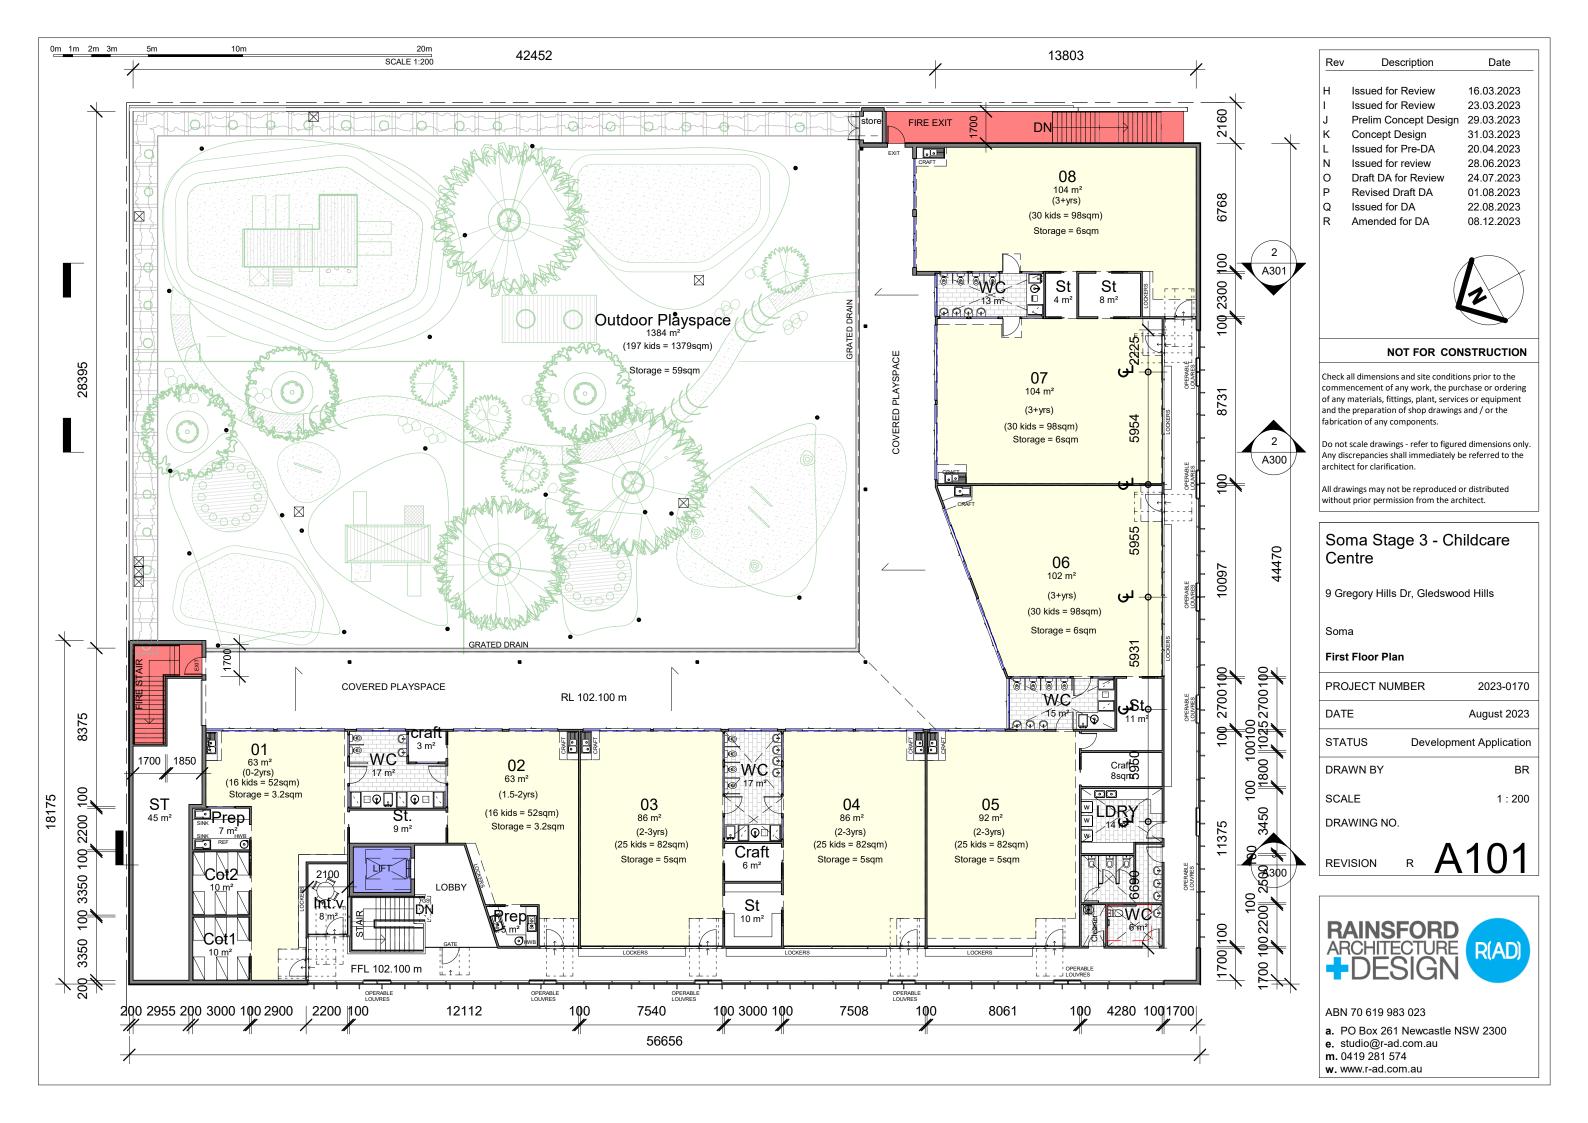





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	9 Gregory Hills Dr, Gleds	wood Hills
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	Demolition Plan	
OR	PROJECT NUMBER	2023-0170
	DATE	August 2023
	STATUS Develo	pment Application
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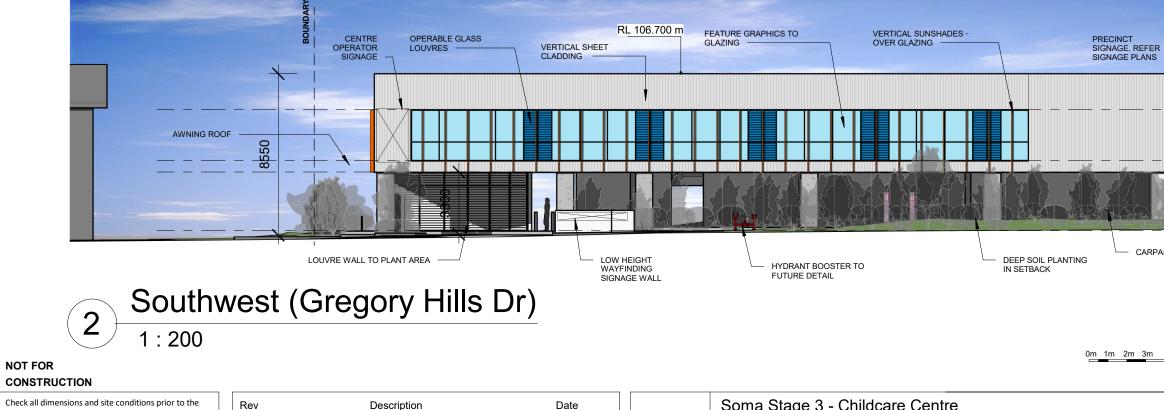




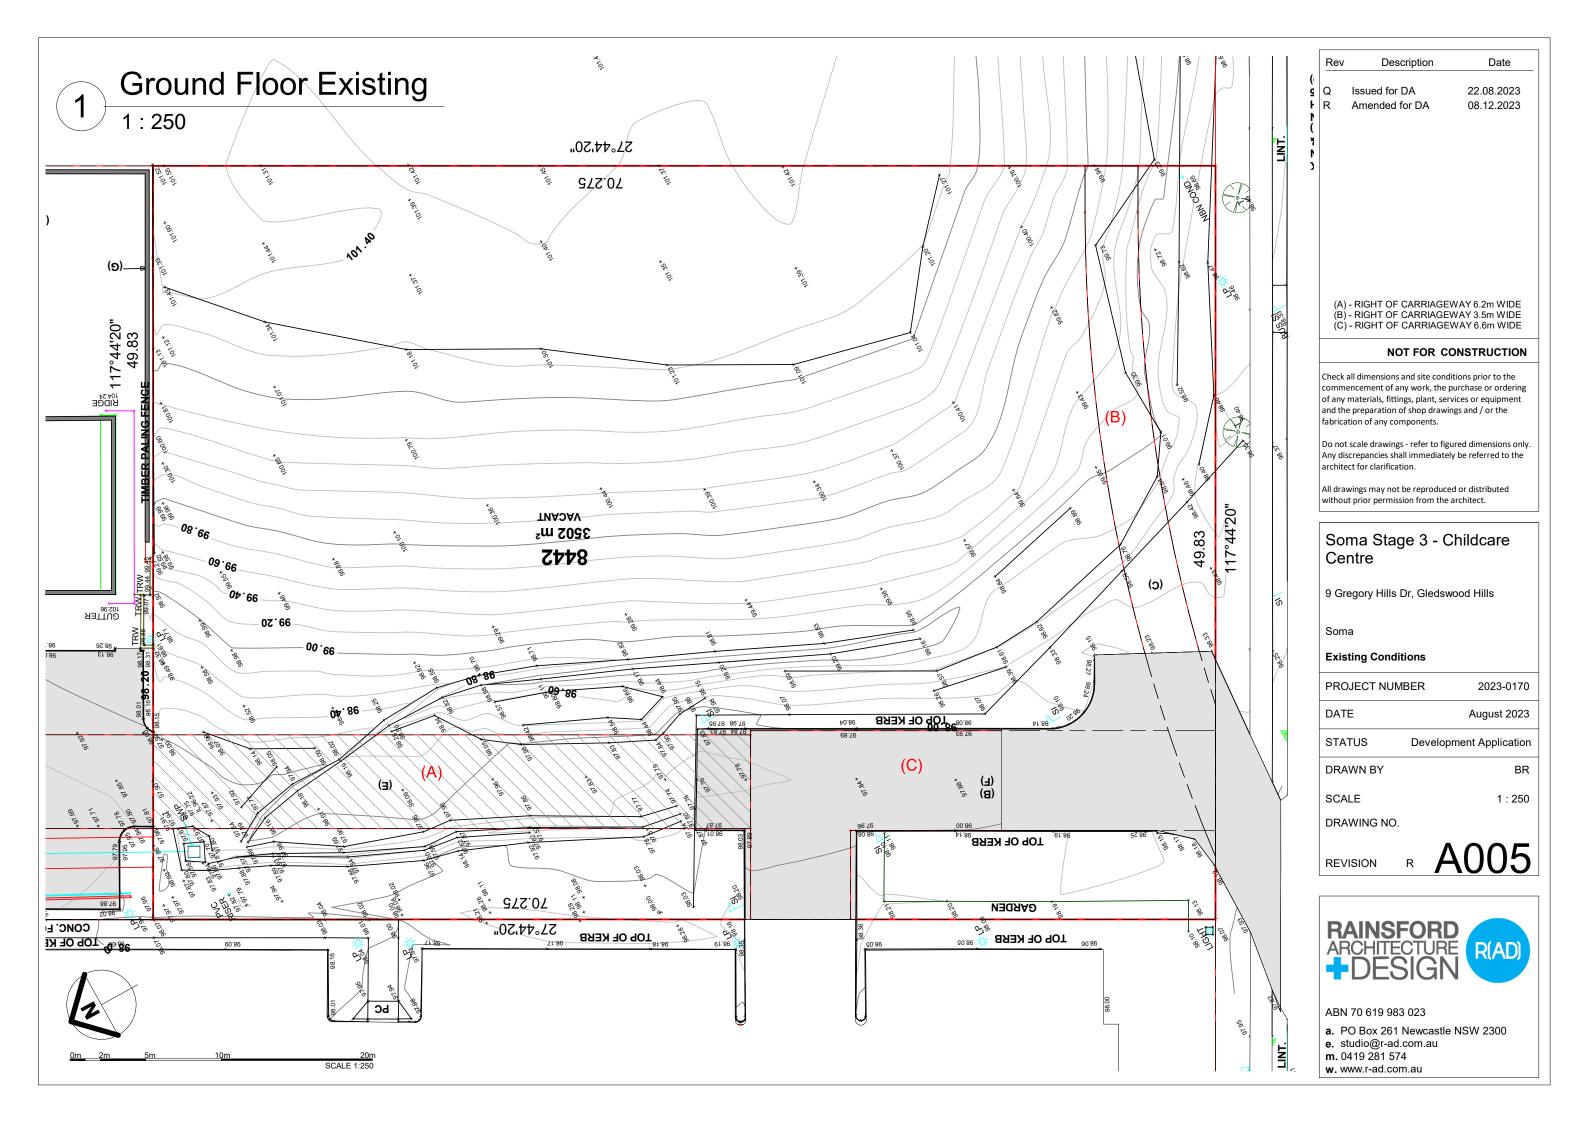



NOTE: REFER TO SIGNAGE CONSULTANT DRAWINGS FOR FEATURE WALL DETAIL, SIGNAGE DETAIL AND CROSSING DETAIL



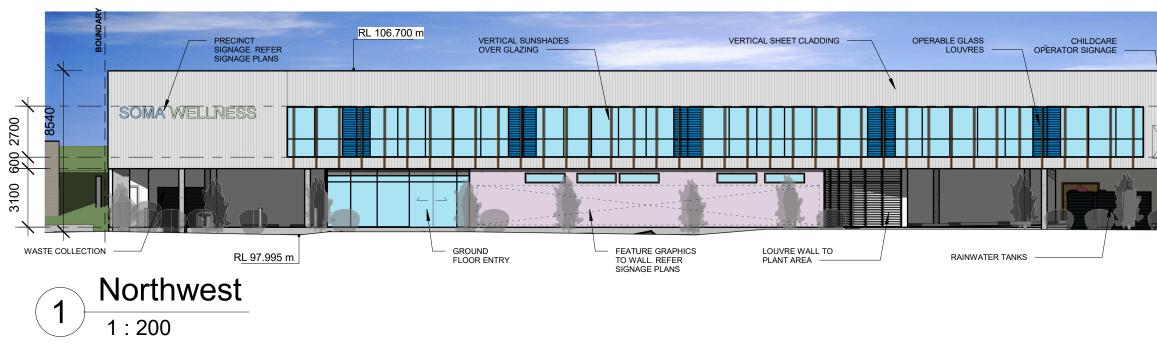


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/ or the fabrication of any components.	L	Issued for Pre-DA	20.04.2023	Elevations		STATUS	Development Application
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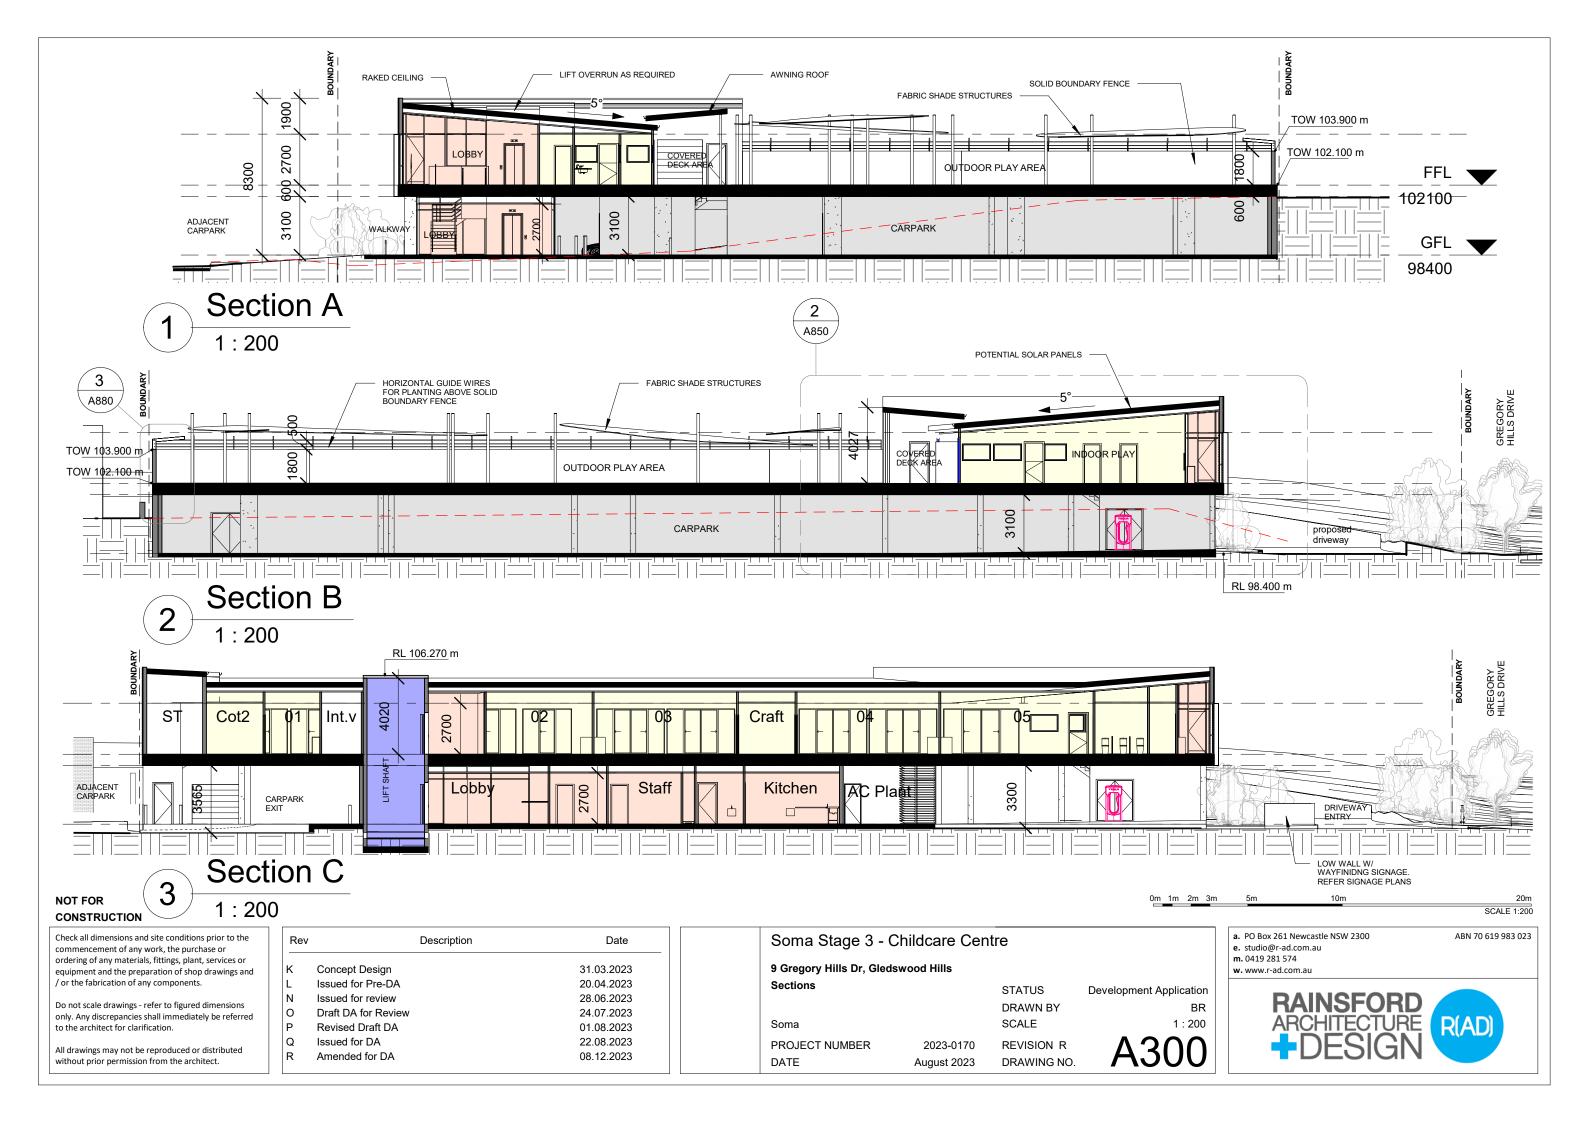


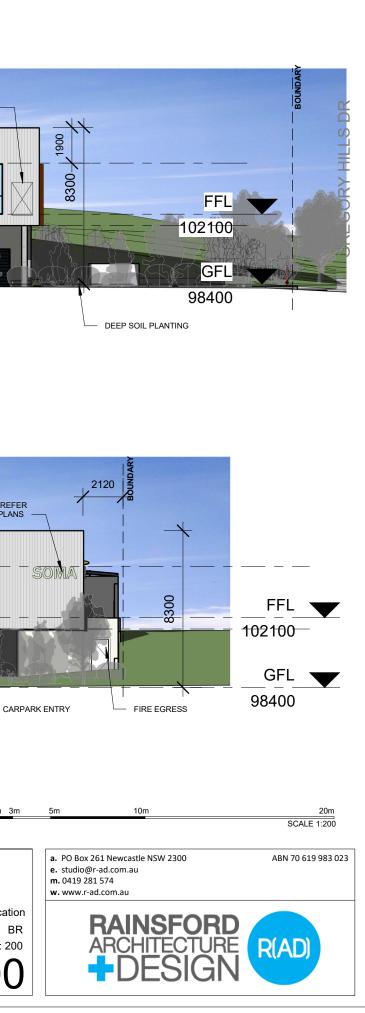

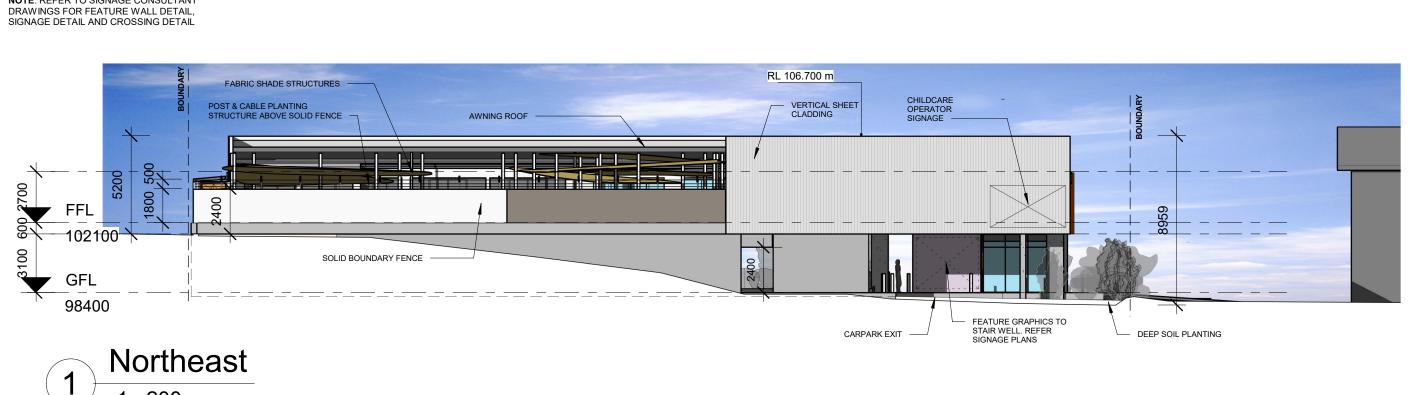
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NOTE: REFER TO SIGNAGE CONSULTANT






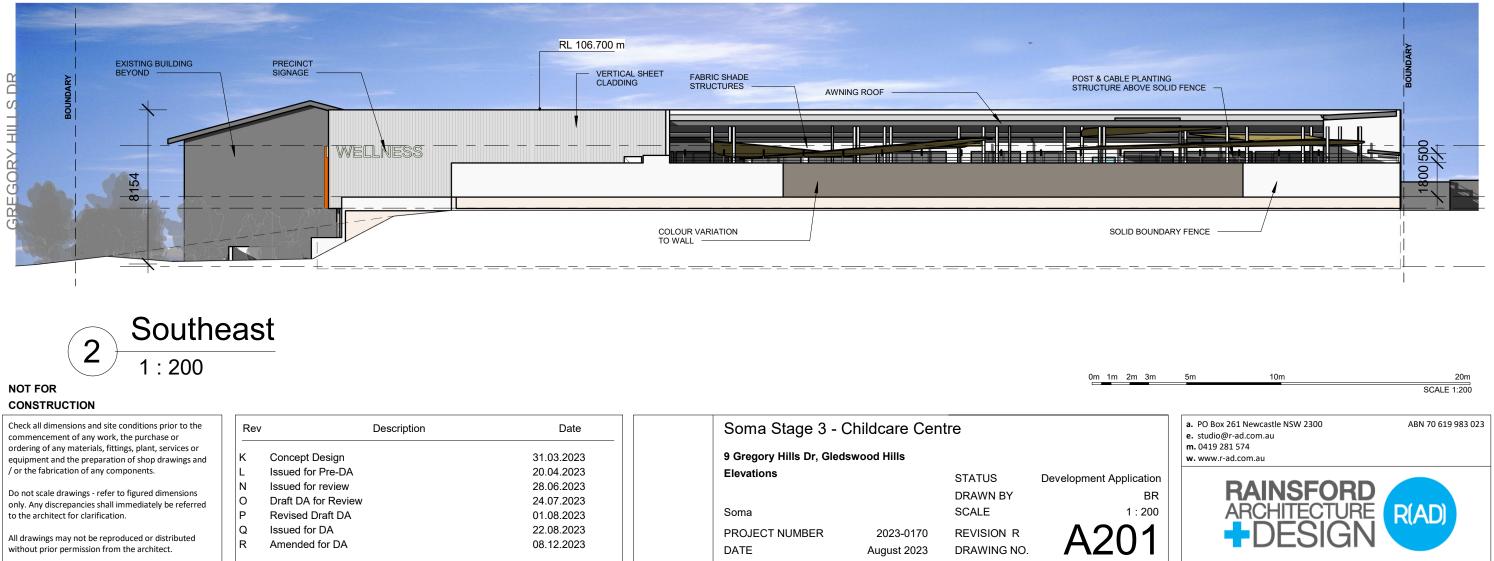
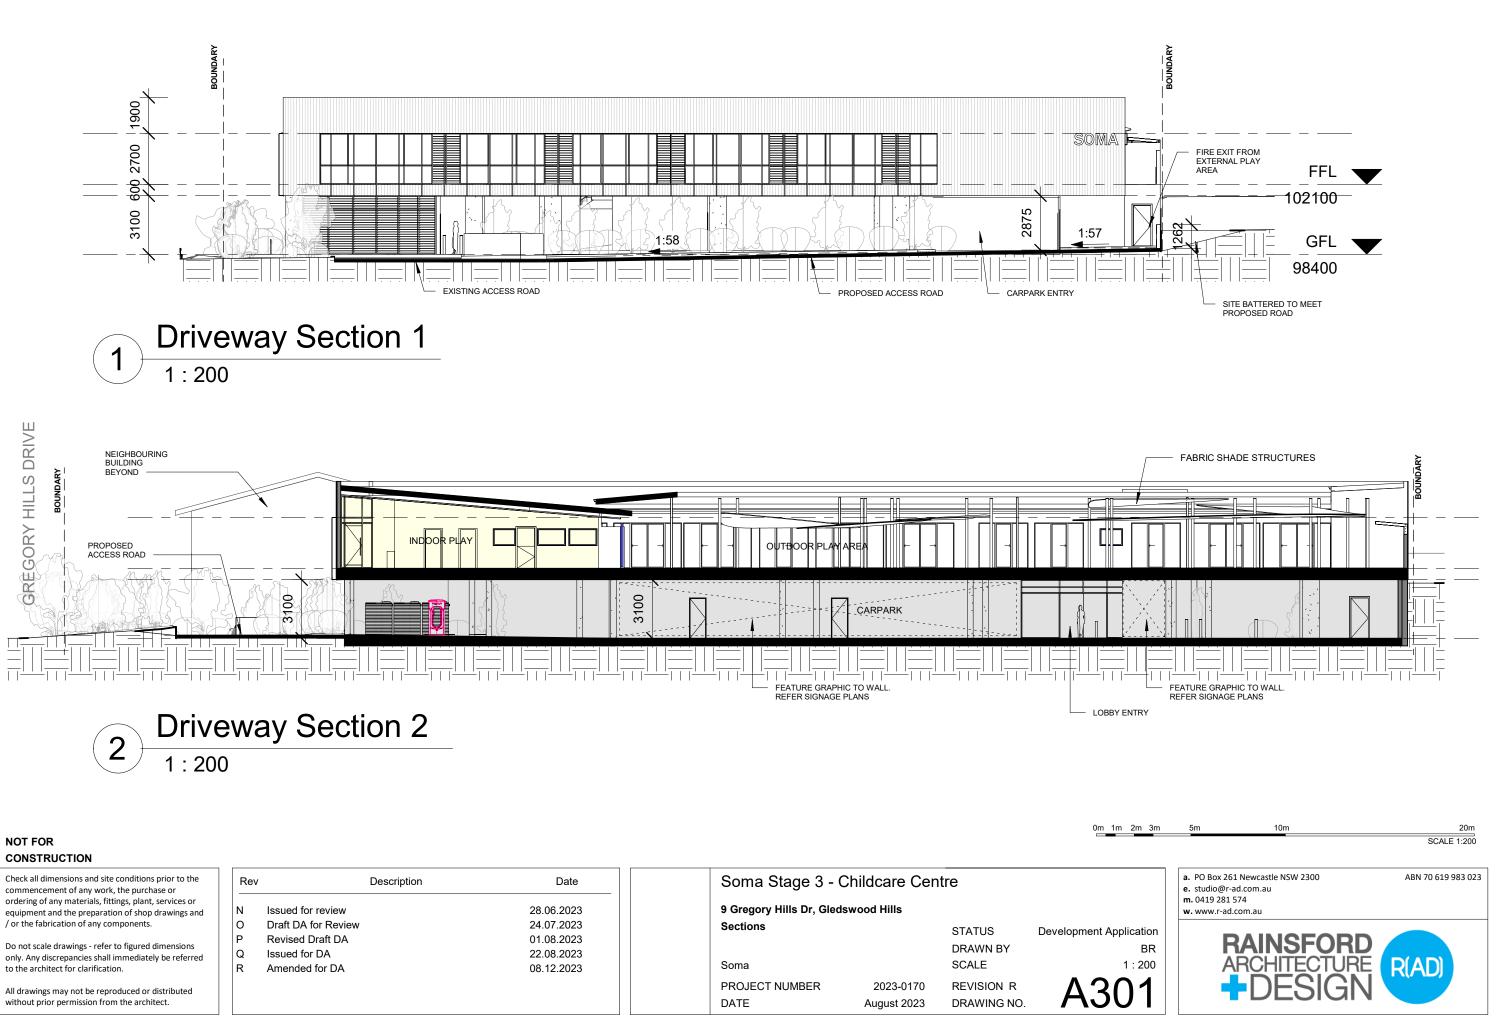
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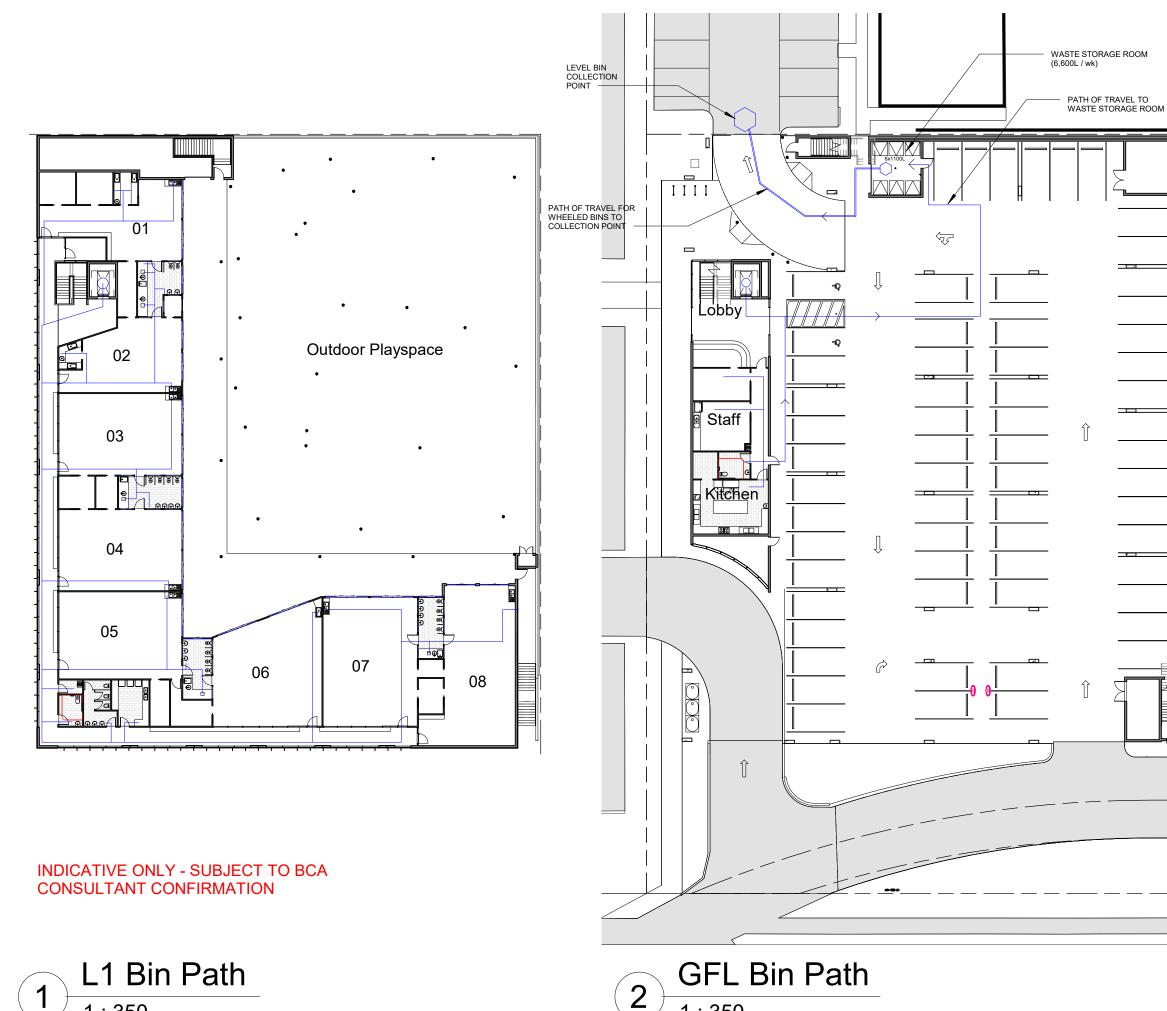




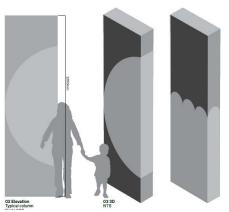


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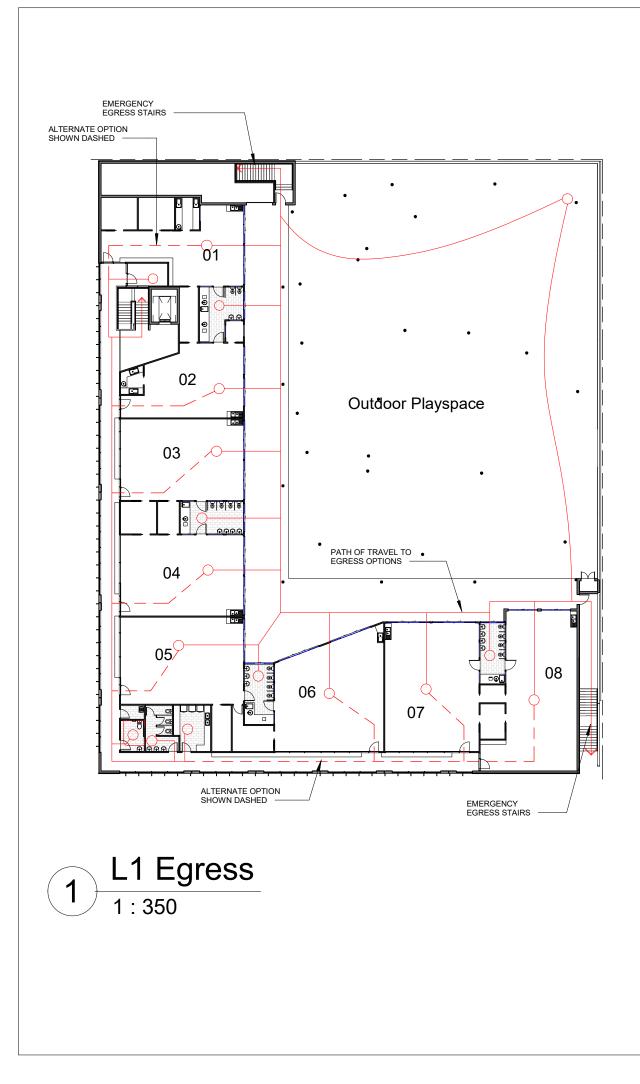



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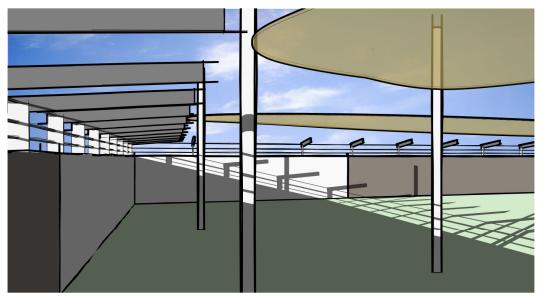
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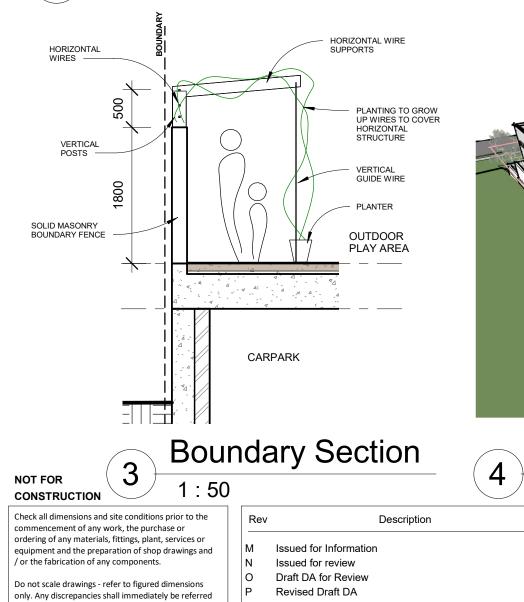






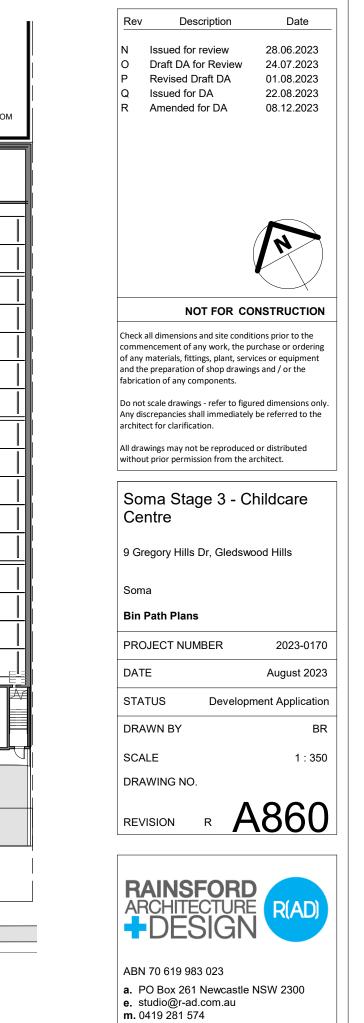

From Adjacent Property 2

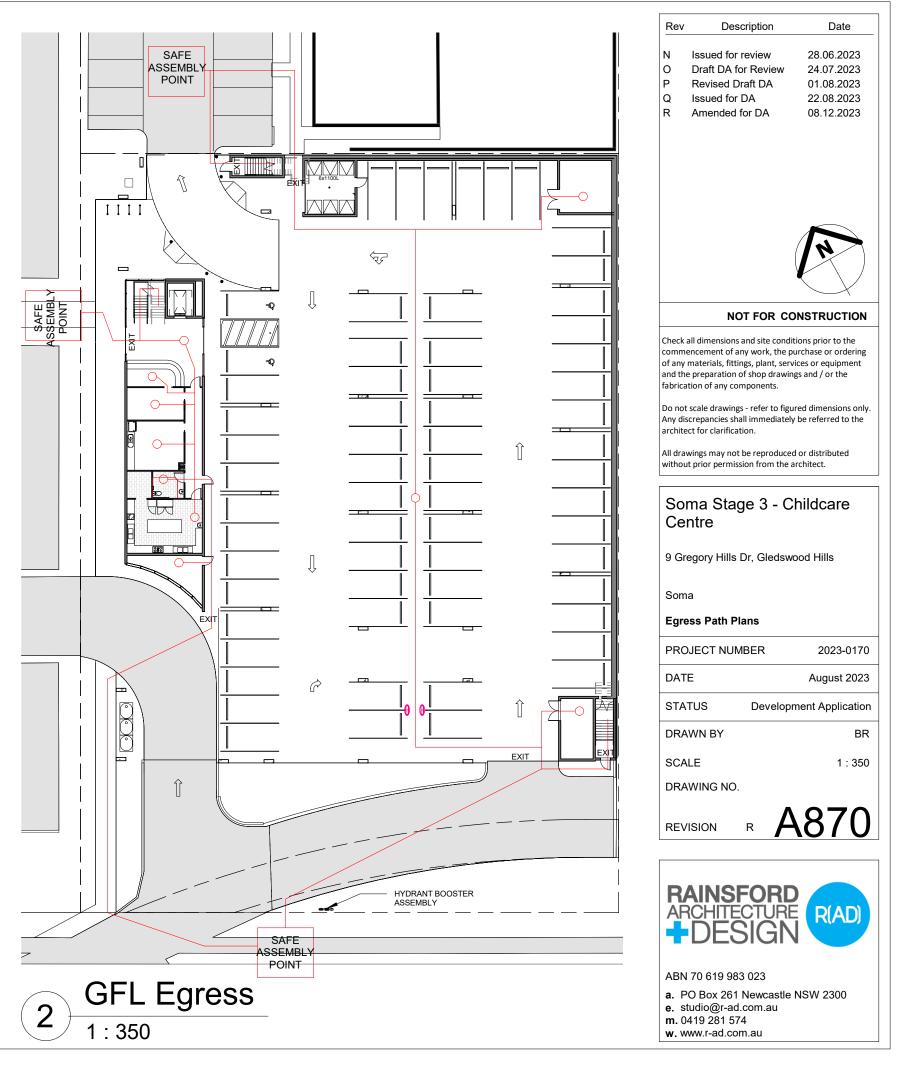

Q

R

Issued for DA

Amended for DA

Playground 2

1

to the architect for clarification.

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Southeast Aerial

cription	Date	Soma Stage 3 - C	Childcare Cen	itre	
	31.05.2023	9 Gregory Hills Dr, Gleds	swood Hills		
	28.06.2023 24.07.2023 01.08.2023 22.08.2023	Boundary Fence Detail		STATUS DRAWN BY SCALE	Development Application BR 1 : 50
	08.12.2023	PROJECT NUMBER DATE	2023-0170 August 2023	REVISION R DRAWING NO.	A880









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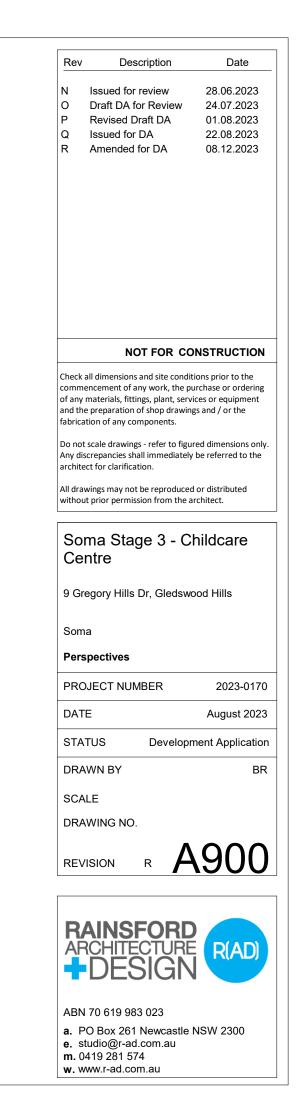
NORTH



NORTHWEST (GREGORY HILLS DRIVE)



SOUTHWEST (GREGORY HILLS DRIVE)



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SOMA Stage 3 Signage **Design Drawings**

Issue for Review 19.12.23

ABCDEFGHIJKLMNOP QRSTUVWXYZ abcdefghijklmnop qrstuvwxyz

Wayfinding Typical application



Health & Wellness

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^{Issue} Issue for Review Revisions A 07.12.23 Issue for DA B 19.12.23 Issue for Review

DA SOMA Review

Project no. SOMA2395

Typography

Project SOMA Stage 3

Date

06.12.23

NOT FOR CONSTRUCTION

Drawn/Checked

Signtype

Drawing number SOMA2395-GEN-002



SOMA Stage 3 Supergraphic palette



SOMA Brand palette



Raising Stars Brand palette



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Scale As shown at A3

Issue Issue for Review

Revisions A 07.12.23 Issue for DA B 19.12.23 Issue for Review Project no. Date SOMA2395 06.12.23 Drawing Palette

Project SOMA Stage 3


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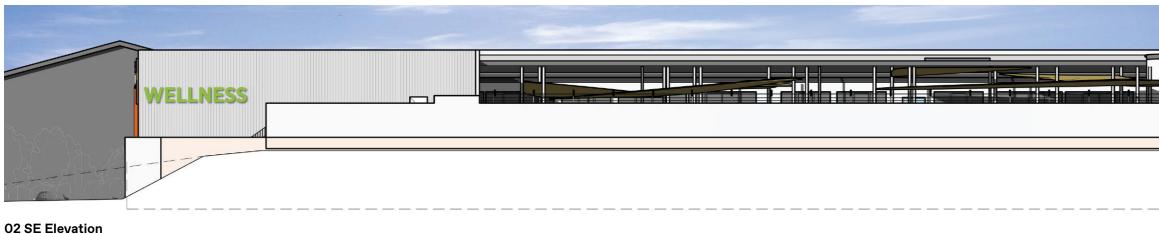
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01 SW Elevation

Gregory Hills Dr-facing facade Scale 1:200



Scale 1:200

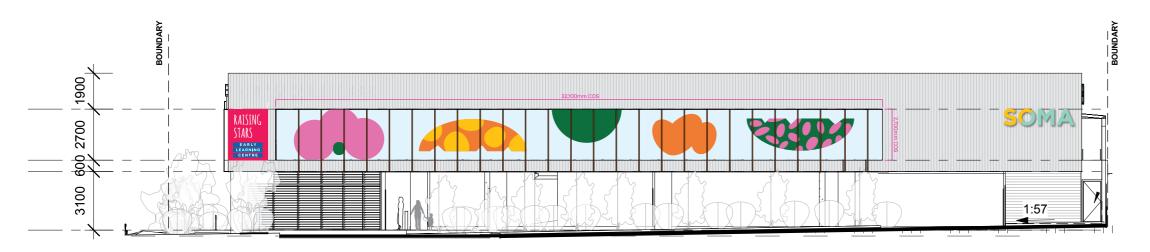

03 NW Elevation SOMA-facing facade

Scale 1:200

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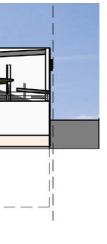
^{Issue} Issue for Review Revisions A 07.12.23 Issue for DA B 19.12.23 Issue for Review

Project no. SOMA2395	Date 06.12.23
Drawing	Project
Precinct	SOMA
Identification	Stage 3

Notes

PURPOSE

The internally illuminated signs are located on the building facade at high level facing vehicluar traffic approaching, and along Gregory Hills Drive and within the SOMA precinct. The signs provide identification for the SOMA Health & Wellness precinct. They are located in relation to key building features and scaled to suit the scale of the facility and long distance viewing for day and night time.





NOT FOR CONSTRUCTION

Drawn/Checked


Signtype 1.1







04 Reference Fabricated internallyilluminated ANTERCONIL. letters CONAA 03 Type detail 800mm cap height Scale 1:20 02 3D NTS

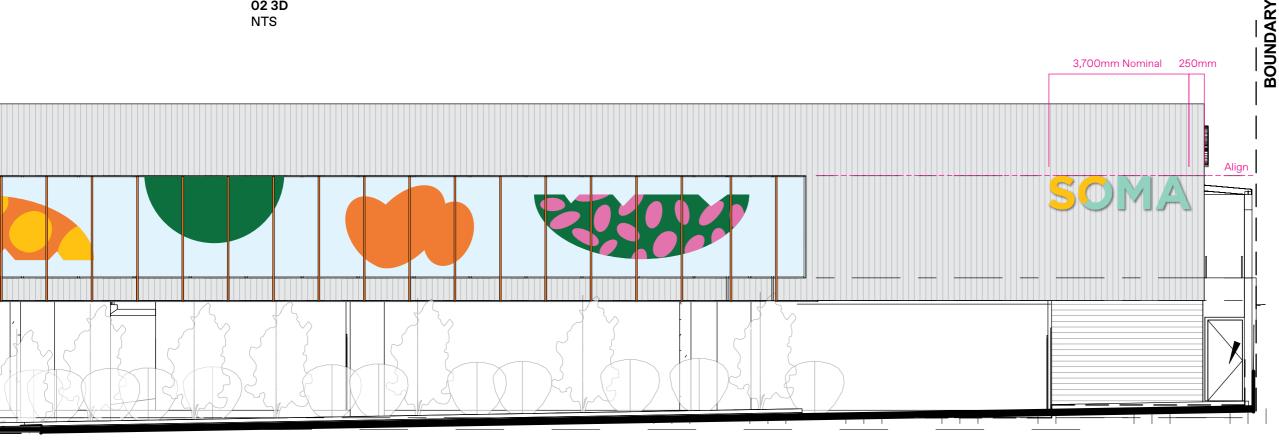

01 Part SW Elevation

Gregory Hills Dr-facing facade Scale 1:100

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Revisions A 07.12.23 Issue for DA B 19.12.23 Issue for Review

Project no. SOMA2395	Date 06.12.23
Drawing Precinct	Project SOMA

Stage 3

Identification



Notes

PURPOSE

The internally illuminated signs are located on the building facade at high level facing vehicluar traffic approaching, and along Gregory Hills Drive. The signs provide identification for the SOMA Health & Wellness precinct.

MATERIALITY

Approximately 100mm deep 3D fabricated letters. Formed up aluminium boxes, with painted aluminium sides and back & acrylic front face. On internal backing to letters to be Celuka panel with LED's fitted to provide an even glow, no hot spots, at night.

FABRICATION

To be rear conceal permanent fixed to base building. All power to be internal and concealed from view through conduits at fixing points to the building.

ILLUMINATION

LED's to be bright warm white Saled Samsung or similar. To have have dimmer control to adjust light output and be linked to building operating systems to allow timer control/switch off.

FINISHES/COLOUR As illustrated

For colour specification refer Graphic standards

To be two pack polyurethane, external grade paint system to all metal surfaces. Anti-graffiti satin clear coat spray finish 25% gloss level to all exposed surfaces.

GRAPHICS

Digital print direct to acylic panels, colour/graphic as illustrated. All fabricated lettering/forms shall be sharp and true to the selected typeface.

Area SOMA: 3m2 Area WELLNESS: 4.35m2

NOT FOR CONSTRUCTION

Drawn/Checked BA/JM

Signtype 1.1









02 Type detail 800mm cap height Scale 1:20



03 3D NTS



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Projec SON	ct no. MA2395	Date 06.12.23
Drawi	ng	Project
Prec	cinct	SOMA
lden	ntification	Stage 3

		Notes Refer drawing SOMA2395-I1-002
	ESS	
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		NOT FOR CONSTRUCTION

NOT FOR CONSTRUCTION

Drawn/Checked BA/JM

Signtype 1.1









02 Type detail 600mm cap height Scale 1:20



3D 600mm cap height NTS



01 Part NW Elevation SOMA-facing facade Scale 1:200

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Project no. SOMA2395	Date 06.12.23
Drawing Precinct	Project SOMA

Identification

SOMA Stage 3



Notes

PURPOSE

The internally illuminated signs are located on the building facade at high level facing the SOMA precinct and carpark. The signs provide identification for the SOMA Health & Wellness precinct.

MATERIALITY

Approximately 100mm deep 3D fabricated letters. Formed up aluminium boxes, with painted aluminium sides and back & acrylic front face. On internal backing to letters to be Celuka panel with LED's fitted to provide an even glow, no hot spots, at night.

FABRICATION

To be rear conceal permanent fixed to base building. All power to be internal and concealed from view through conduits at fixing points to the building.

ILLUMINATION

LED's to be bright warm white Saled Samsung or similar. To have have dimmer control to adjust light output and be linked to building operating systems to allow timer control/switch off.

FINISHES/COLOUR As illustrated

For colour specification refer Graphic standards

To be two pack polyurethane, external grade paint system to all metal surfaces. Anti-graffiti satin clear coat spray finish 25% gloss level to all exposed surfaces.

GRAPHICS

Digital print direct to acylic panels, colour/graphic as illustrated. All fabricated lettering/forms shall be sharp and true to the selected typeface.

Area SOMA WELLNESS: 3.3m2

NOT FOR CONSTRUCTION

Drawn/Checked

Signtype












01 SW Elevation

Gregory Hills Dr-facing facade Scale 1:200



O2 NW Elevation SOMA-facing facade Scale 1:200

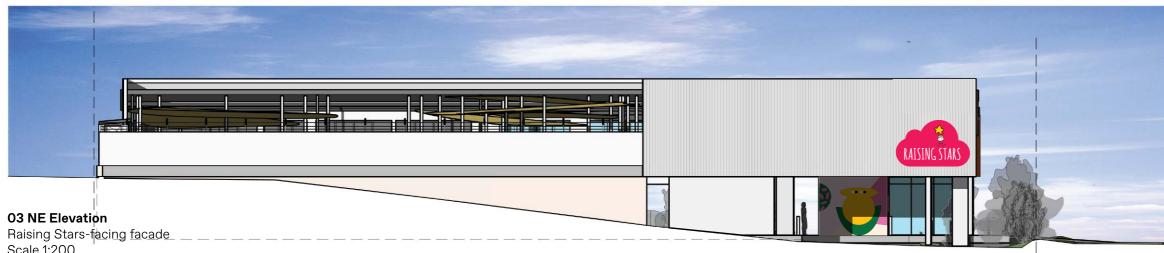

Scale 1:200

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Project no.	Date
SOMA2395	06.12.23
Drawing	Project
Building	SOMA
Identification	Stage 3

Notes

PURPOSE

The internally illuminated signs are located on the building facade at high level facing vehicluar traffic approaching, and along Gregory Hills Drive and from approach off Digitaria Drive. The signs provide identification for Raising Stars Early Learning. They are located in relation to key building features and scaled to suit the scale of the facility and long distance viewing for day and night time.






NOT FOR CONSTRUCTION

Drawn/Checked

Signtype





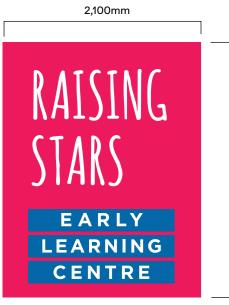

02 Elevation

Scale 1:50


2,700mm

STARS

03 Detail 650mm cap height Scale 1:20



04 Detail 175mm cap height Scale 1:20

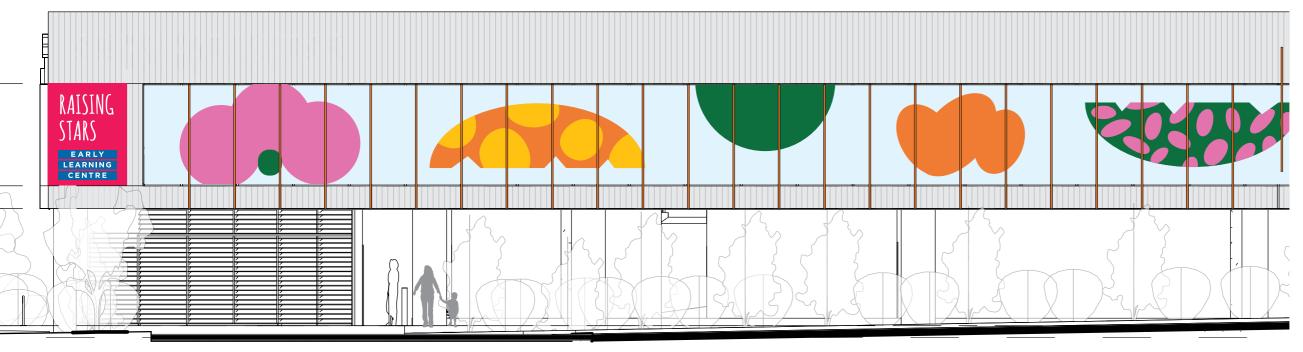

O1 Part SW Elevation Gregory Hills Dr-facing facade Scale 1:100

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Project no. SOMA2395	Date 06.12.23
Drawing	Project
Building	SOMA
Identification	Stage 3

Notes

PURPOSE

The internally illuminated sign is located on the building facade at high level facing vehicluar traffic along Gregory Hills Drive and on approach at the primary vehicular entry to the facility. The signs provide identification for the childcare.

MATERIALITY

Approximately 100mm deep 3D fabricated signbox. Formed up aluminium box, with painted aluminium sides and back & acrylic front face. On internal backing to signbox to be Celuka panel with LED's fitted to provide an even glow, no hot spots, at night.

FABRICATION

To be rear conceal permanent fixed to base building. All power to be internal and concealed from view through conduits at fixing points to the building.

ILLUMINATION

LED's to be bright warm white Saled Samsung or similar. To have have dimmer control to adjust light output and be linked to building operating systems to allow timer control/switch off.

FINISHES/COLOUR As illustrated

For colour specification refer Graphic standards

To be two pack polyurethane, external grade paint system to all metal surfaces. Anti-graffiti satin clear coat spray finish 25% gloss level to all exposed surfaces.

GRAPHICS

Digital print direct to acylic panel, colour/graphic as illustrated. All printed lettering/forms shall be sharp and true to the selected typeface.

Area: 5.67m2

NOT FOR CONSTRUCTION


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Signtype









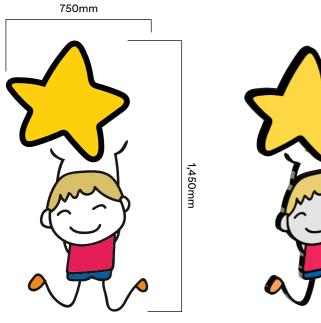

02 Detail elevation Scale 1:20

03 3D NTS



01 Part NW Elevation SOMA-facing facade Scale 1:100

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Project no. SOMA2395	Date 06.12.23
Drawing Building	Project SOMA

Stage 3

Identification

Notes

PURPOSE

The sign is located on the building facade at high level facing the SOMA precinct and carpark. The graphic provides identification for the childcare through the animation.

MATERIALITY

2mm painted Aluminium sign panel water jet cut to form illustrated with digital print graphics direct to sign panel. Rear conceal adhesive fixed to building substrate.

FINISHES/COLOUR As illustrated For colour specification refer Graphic standards

To be two pack polyurethane, external grade paint system to all metal surfaces. Anti-graffiti satin clear coat spray finish 25% gloss level to all exposed surfaces.

GRAPHICS

Digital print graphic direct to painted sign panel, as illustrated on elevation and noted in documentation. All lettering/forms shall be sharp and true to the selected typeface.

Area: 1.1m2

NOT FOR CONSTRUCTION

Drawn/Checked BA/JM

Signtype 1.2







3,800mm COS 2,400mm COS RAISING STARS

02 Detail elevation Scale 1:50

STARS

03 Type detail 625mm cap height Scale 1:20



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Issue Issue for Review

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Project no.	Date
SOMA2395	06.12.23
Drawing	Project

Building

roject SOMA Identification Stage 3

Notes

PURPOSE

The internally illuminated sign is located on the building facade at high level facing vehicluar traffic on Digitaria Drive and the ongrade carpark in the foreground. The sign provides identification for the childcare.

MATERIALITY

Approximately 100mm deep 3D fabricated signbox. Formed up aluminium box to shape illustrated, with painted aluminium sides and back & acrylic front face. On internal backing to signbox to be Celuka panel with LED's fitted to provide an even glow, no hot spots, at night.

FABRICATION

To be rear conceal permanent fixed to base building. All power to be internal and concealed from view through conduits at fixing points to the building.

ILLUMINATION

LED's to be bright warm white Saled Samsung or similar. To have have dimmer control to adjust light output and be linked to building operating systems to allow timer control/switch off.

FINISHES/COLOUR As illustrated

For colour specification refer Graphic standards

To be two pack polyurethane, external grade paint system to all metal surfaces. Anti-graffiti satin clear coat spray finish 25% gloss level to all exposed surfaces.

GRAPHICS

Digital print direct to acylic panel, colour/graphic as illustrated. All printed lettering/forms shall be sharp and true to the selected typeface.

Area: 9m2

NOT FOR CONSTRUCTION



Signtype 1.2









Health & **Wellness**

02 Type detail 100mm cap height Scale 1:10



03 Logo detail 150mm cap height Scale 1:10



Health

04 3D NTS



01 Elevation

Entry-facing low wall Scale 1:20

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Project no. SOMA2395
Drawing Precinct

Vehicular

Directional

Date

Project

SOMA

Stage 3

06.12.23

Notes

PURPOSE

The signs are located on a low masonry wall facing vehicluar traffic approaching from Gregory Hills Drive. The sign provides directional content to assist in wayfinding to the SOMA Health & Wellness precinct and to the Raising Stars Early Learning centre facility.

MATERIALITY Panel; 2mm painted Aluminium sign panel with digital print graphics direct to painted sign panel.

Letters/arrows; 2mm water jet cut painted Aluminium panel fabricated to form/letter as illustrated.

Rear conceal adhesive fixed to building substrate.

FINISHES/COLOUR As illustrated

For colour specification refer Graphic standards

To be two pack polyurethane, external grade paint system. Anti-graffiti satin clear coat spray finish 25% gloss level to all exposed surfaces.

GRAPHICS Panel; Digital print graphic direct to painted sign panel, as illustrated on elevation and noted in documentation.

All lettering/forms shall be sharp and true to the selected typeface.


Area Health & Wellness: 0.35m2

Area SOMA: 0.65m2


Area Raising Stars: 0.6m2

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01 Part plan Carpark Scale 1:100

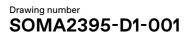

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06.12.23
Project SOMA
SONA Stage 3

Notes

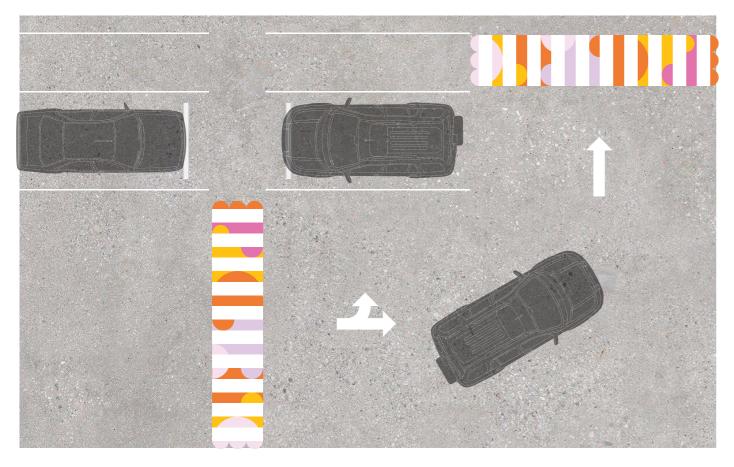PURPOSE

The crossing graphics are located at 4 crossings under the building to animate the journey from car to facility. The colour graphics augment the standard white dashed crossing by 'filling' in the gaps between the white bands

MATERIALITY

White crossing to be line marking paint to direct to the carpark ground surface, as per architects road markings documentation and as per AS/BCA regulations.

Coloured infill graphics/text to be mask & spray painted with DULUX 2-pak external grade paint system, or similar appropriate for location.

FINISHES/COLOUR As illustrated

For colour specification refer Graphic standards

White crossing; slip-resistant retro-reflective thermoplastic paint, or as specified by architects.

Coloured infill; two pack polyurethane, external grade paint system. Anti-graffiti satin clear coat spray finish 25% gloss level to all exposed surfaces.

GRAPHICS

Coloured infill graphic to be mask & spray via vinyl cut template and spray painted directly to wall surface.

NOT FOR CONSTRUCTION


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02 Montage NTS



O1 NW Elevation SOMA-facing wall Scale 1:50

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Project no. SOMA2395	Date 06.12.23
Drawing	Project
Arrival	SOMA
feature	Stage 3

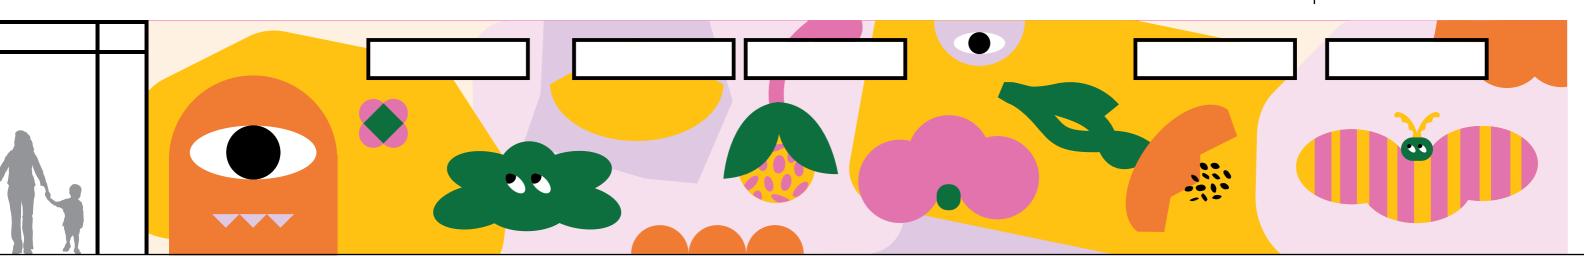

Notes

PURPOSE

The graphics are located on the primary built form at ground level wrapping the solid masonry walls adjacent the glazed entries to the facility. The graphics have a varied scale to respond to long distance viewing on arrival at the site and from the adjacent SOMA Wellness facility, and with detail at low level to engage with the primary users of the facility in close proximity.

MATERIALITY

Graphics/text to be mask & spray painted with DULUX 2-pak external grade paint system, or similar appropriate for location

FINISHES/COLOUR As illustrated

For colour specification refer Graphic standards

To be two pack polyurethane, external grade paint system. Anti-graffiti satin clear coat spray finish 25% gloss level to all exposed surfaces.

GRAPHICS Graphic to be mask & spray via vinyl cut template and spray painted directly to wall surface.

Area carpark facing wall: 79m2

Area end wall: 11m2

Area SOMA facing wall: 58m2

NOT FOR CONSTRUCTION


Drawn/Checked


Signtype **P.1**








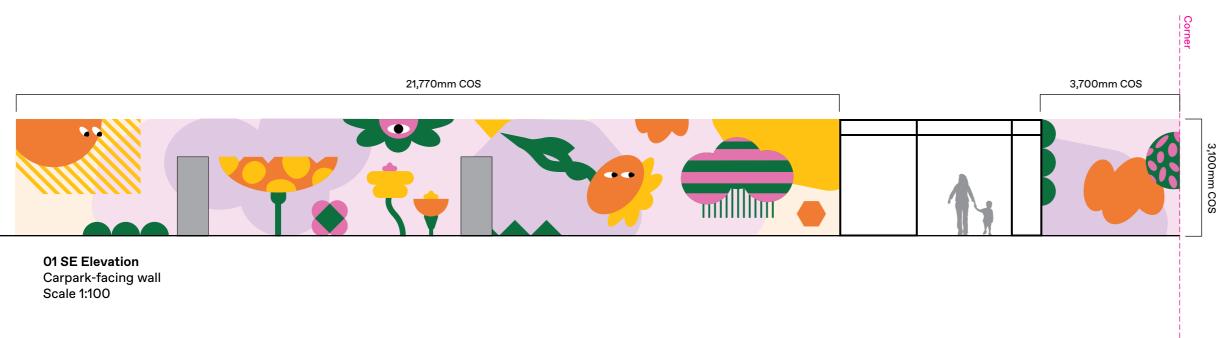

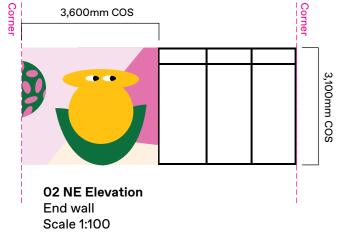

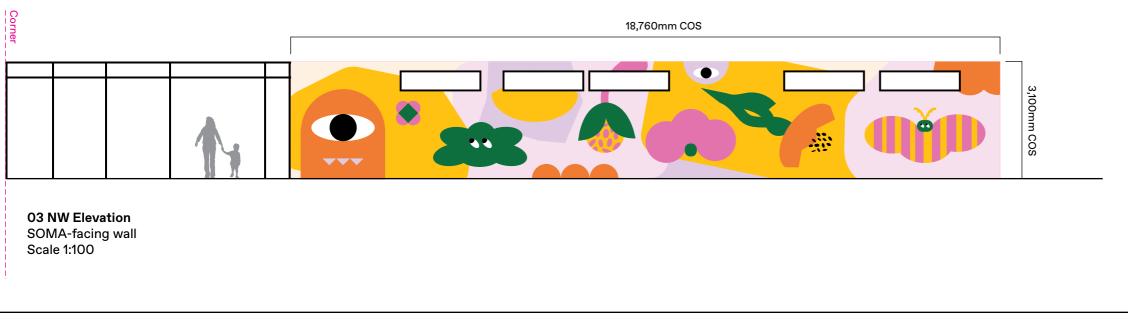

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Project no. SOMA2395	Date 06.12.23
Drawing	Project
Arrival	SOMA
feature	Stage 3

Notes

Refer drawing SOMA2395-P1-001.

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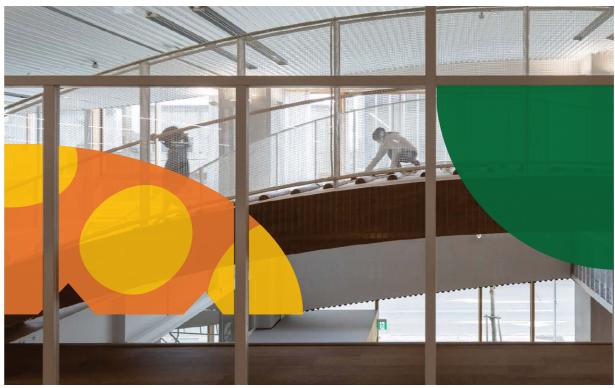
Drawn/Checked

Signtype **P.1**









02 Reference One-way vision perforated vinyl

03 Montage NTS



01 SW Elevation

Gregory Hills Dr-facing facade Scale 1:100

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Project no. SOMA2395	Date 06.12.23
Drawing	Project
Facade	SOMA
feature	Stage 3

Notes

PURPOSE

The window graphics are located on the primary facade facing Gregory Hills Drive. The graphics animate the facade for vehicluar traffic externally and internally the children and staff in the facility through colour, form and patterning.

MATERIALITY

To be digitally printed graphics to a premium self-adhesive one-way vision vinyl installed to manufacturers specifications to inside facing of glazing.

FINISHES/COLOUR As illustrated

For colour specification refer Graphic standards.

GRAPHICS

Digital print graphic direct to premium one-way vision vinyl, as illustrated on elevation and noted in documentation. To be two pack proprietory ink system, suitable for the vinyl film.

Area window: 86.7m2

Area each shape approx: 7.5m2


NOT FOR CONSTRUCTION

Drawn/Checked

Signtype P.2





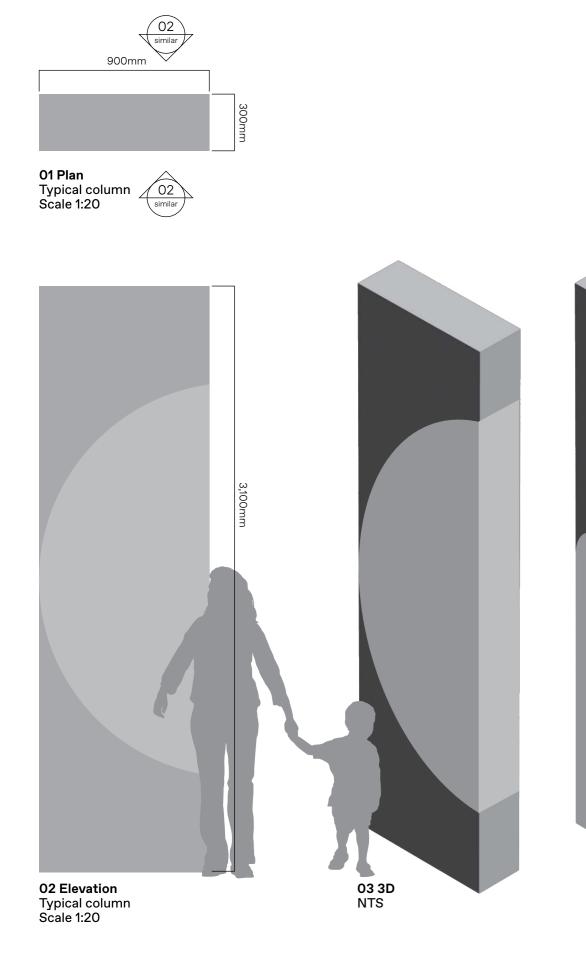



Paint colour to vertical edge of stair to be Supergraphic Lilac, refer drawing SOMA2395-GEN-003 & architects documentation.

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NTS

Issue Issue for Review

Revisions A 07.12.23 Issue for DA B 19.12.23 Issue for Review

	Project no. SOMA2395	Date 06.12.23
[Drawing	Project
(Column	SOMA
ť	feature	Stage 3

Notes

PURPOSE

The column graphics are located under the building to animate the journey from car to facility and through the use of colour zone the carpark to assist in wayfinding.

MATERIALITY

Graphics/text to be mask & spray painted with DULUX 2-pak external grade paint system, or similar appropriate for location

FINISHES/COLOUR As illustrated

For colour specification refer Graphic standards

To be two pack polyurethane, external grade paint system. Anti-graffiti satin clear coat spray finish 25% gloss level to all exposed surfaces.

GRAPHICS

Graphic to be mask & spray via vinyl cut template and spray painted directly to wall surface.

NOT FOR CONSTRUCTION


Drawn/Checked BA/JM


Signtype P.3







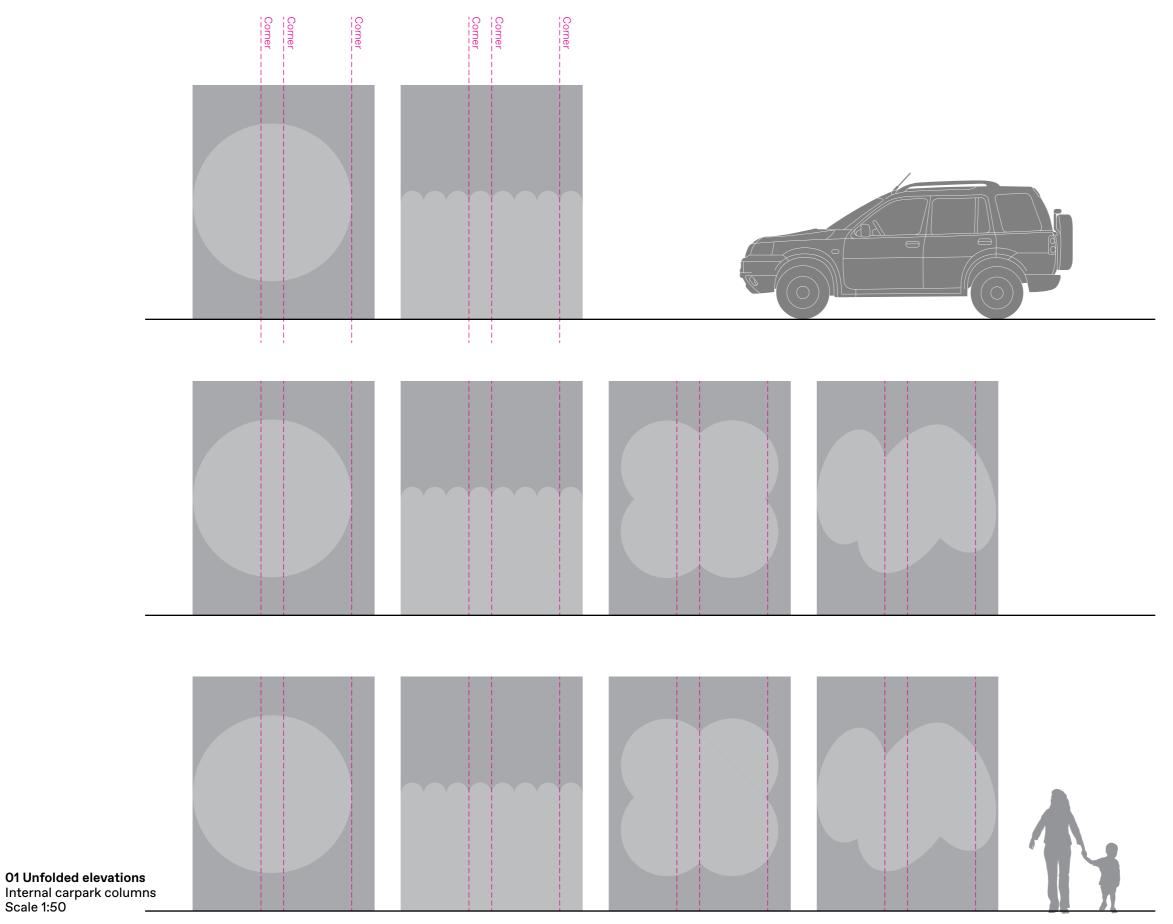

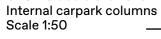

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Project no.	Date
SOMA2395	06.12.23
Drawing	Project
Column	SOMA
feature	Stage 3


Notes

Refer drawing SOMA2395-P3-001


NOT FOR CONSTRUCTION


Drawn/Checked BA/JM

Signtype P.3

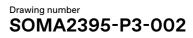



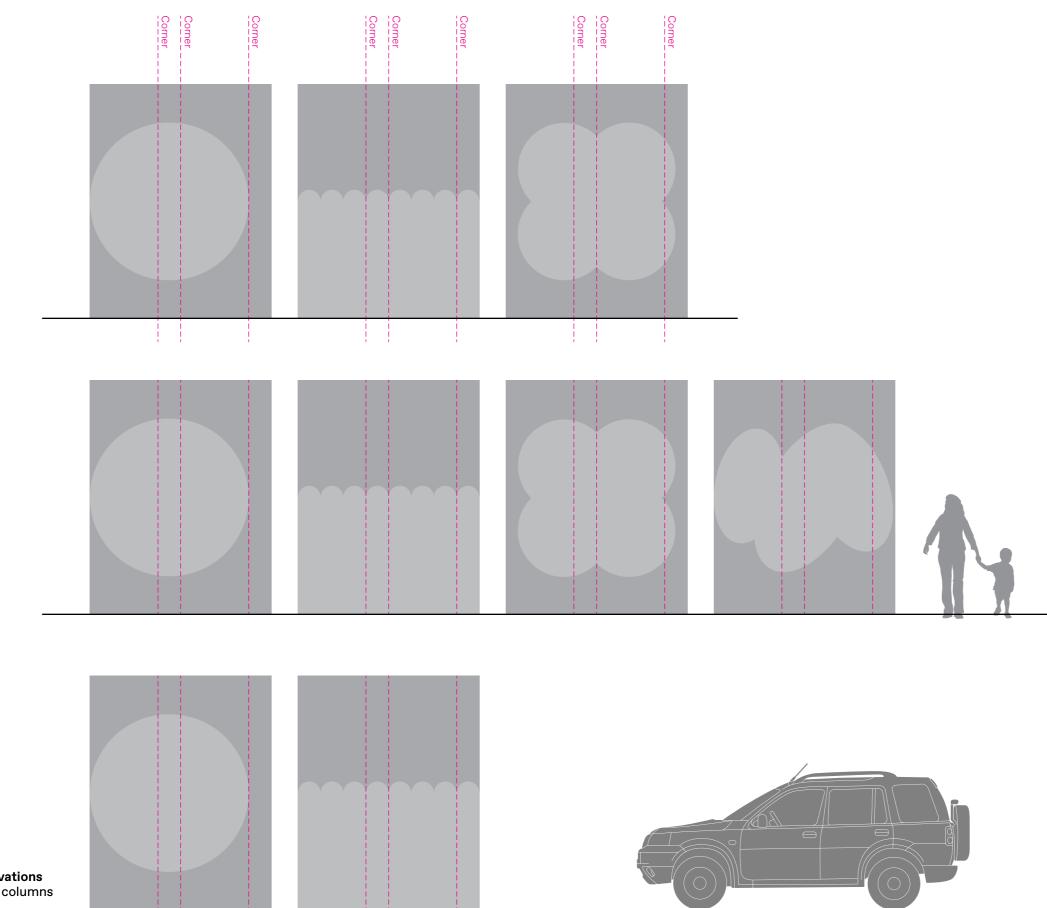

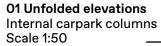

M > < T Written dimensions take precedence over scaled dimensions. Contractors shall verify all critical dimensions on site prior to commencement of work. Reproduction of the whole or part of this document constitutes an infringement of copyright. This information ideas and concepts contained in this document are confidential. The recipient(s) of this document is prohibited from disclosing such information, ideas and concepts to any person without prior written consent of Studio MAAT.

Studio MAAT studiomaat.com.au

Joanna Mackenzie 0421 669 671 joanna@studiomaat.com.au Bridget Atkinson 0423 170 481 bridget@studiomaat.com.au _{Scale} As shown at A3

^{Issue} Issue for Review Revisions A 07.12.23 Issue for DA B 19.12.23 Issue for Review

Project no. SOMA2395	Date 06.12.23
Drawing	Project
Column	SOMA
feature	Stage 3


Notes

Refer drawing SOMA2395-P3-001

NOT FOR CONSTRUCTION

Drawn/Checked

Signtype P.3

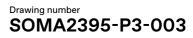



CON TOUR LANDSCAPE ARCHITECTURE

DA DOCUMENTATION

PROJECT

SOMA Stage 3 Childcare Centre

ADDRESS

9 Gregory Hills Drive, Gledswood Hills NSW 2557



SITE LOCATION



RENDER (by others)






PROJECT SOMA Stage 3 Childcare Centre 9 Gregory Hills Drive, Gledswood Hills NSW 2557

NOTES comply with building code of australia and all relevant australian standards all works shall be in accordance with development application and construction certificate conditions of consent all levels to ahd all levels to and refer to survey information relating to existing site data verify all dimensions prior to works do not scale from drawings use figured dimensions in preference to scaling refer all descrepancies to landscape architect for determination this drawing is copyright and must not be retained, copied, used or reproduced in any way without prior written permission of contour landscape architects.

<u>DATE REV. ISSUE</u> 19/04/23 A	DATE:	03/07/23	DRAWING SITE PLAN
29/05/23 B 02/06/23 C 03/07/23 D	SCALE:	1:500 @ A2	DRAWING NO: C1
	DRAWN:	SEC	REV:

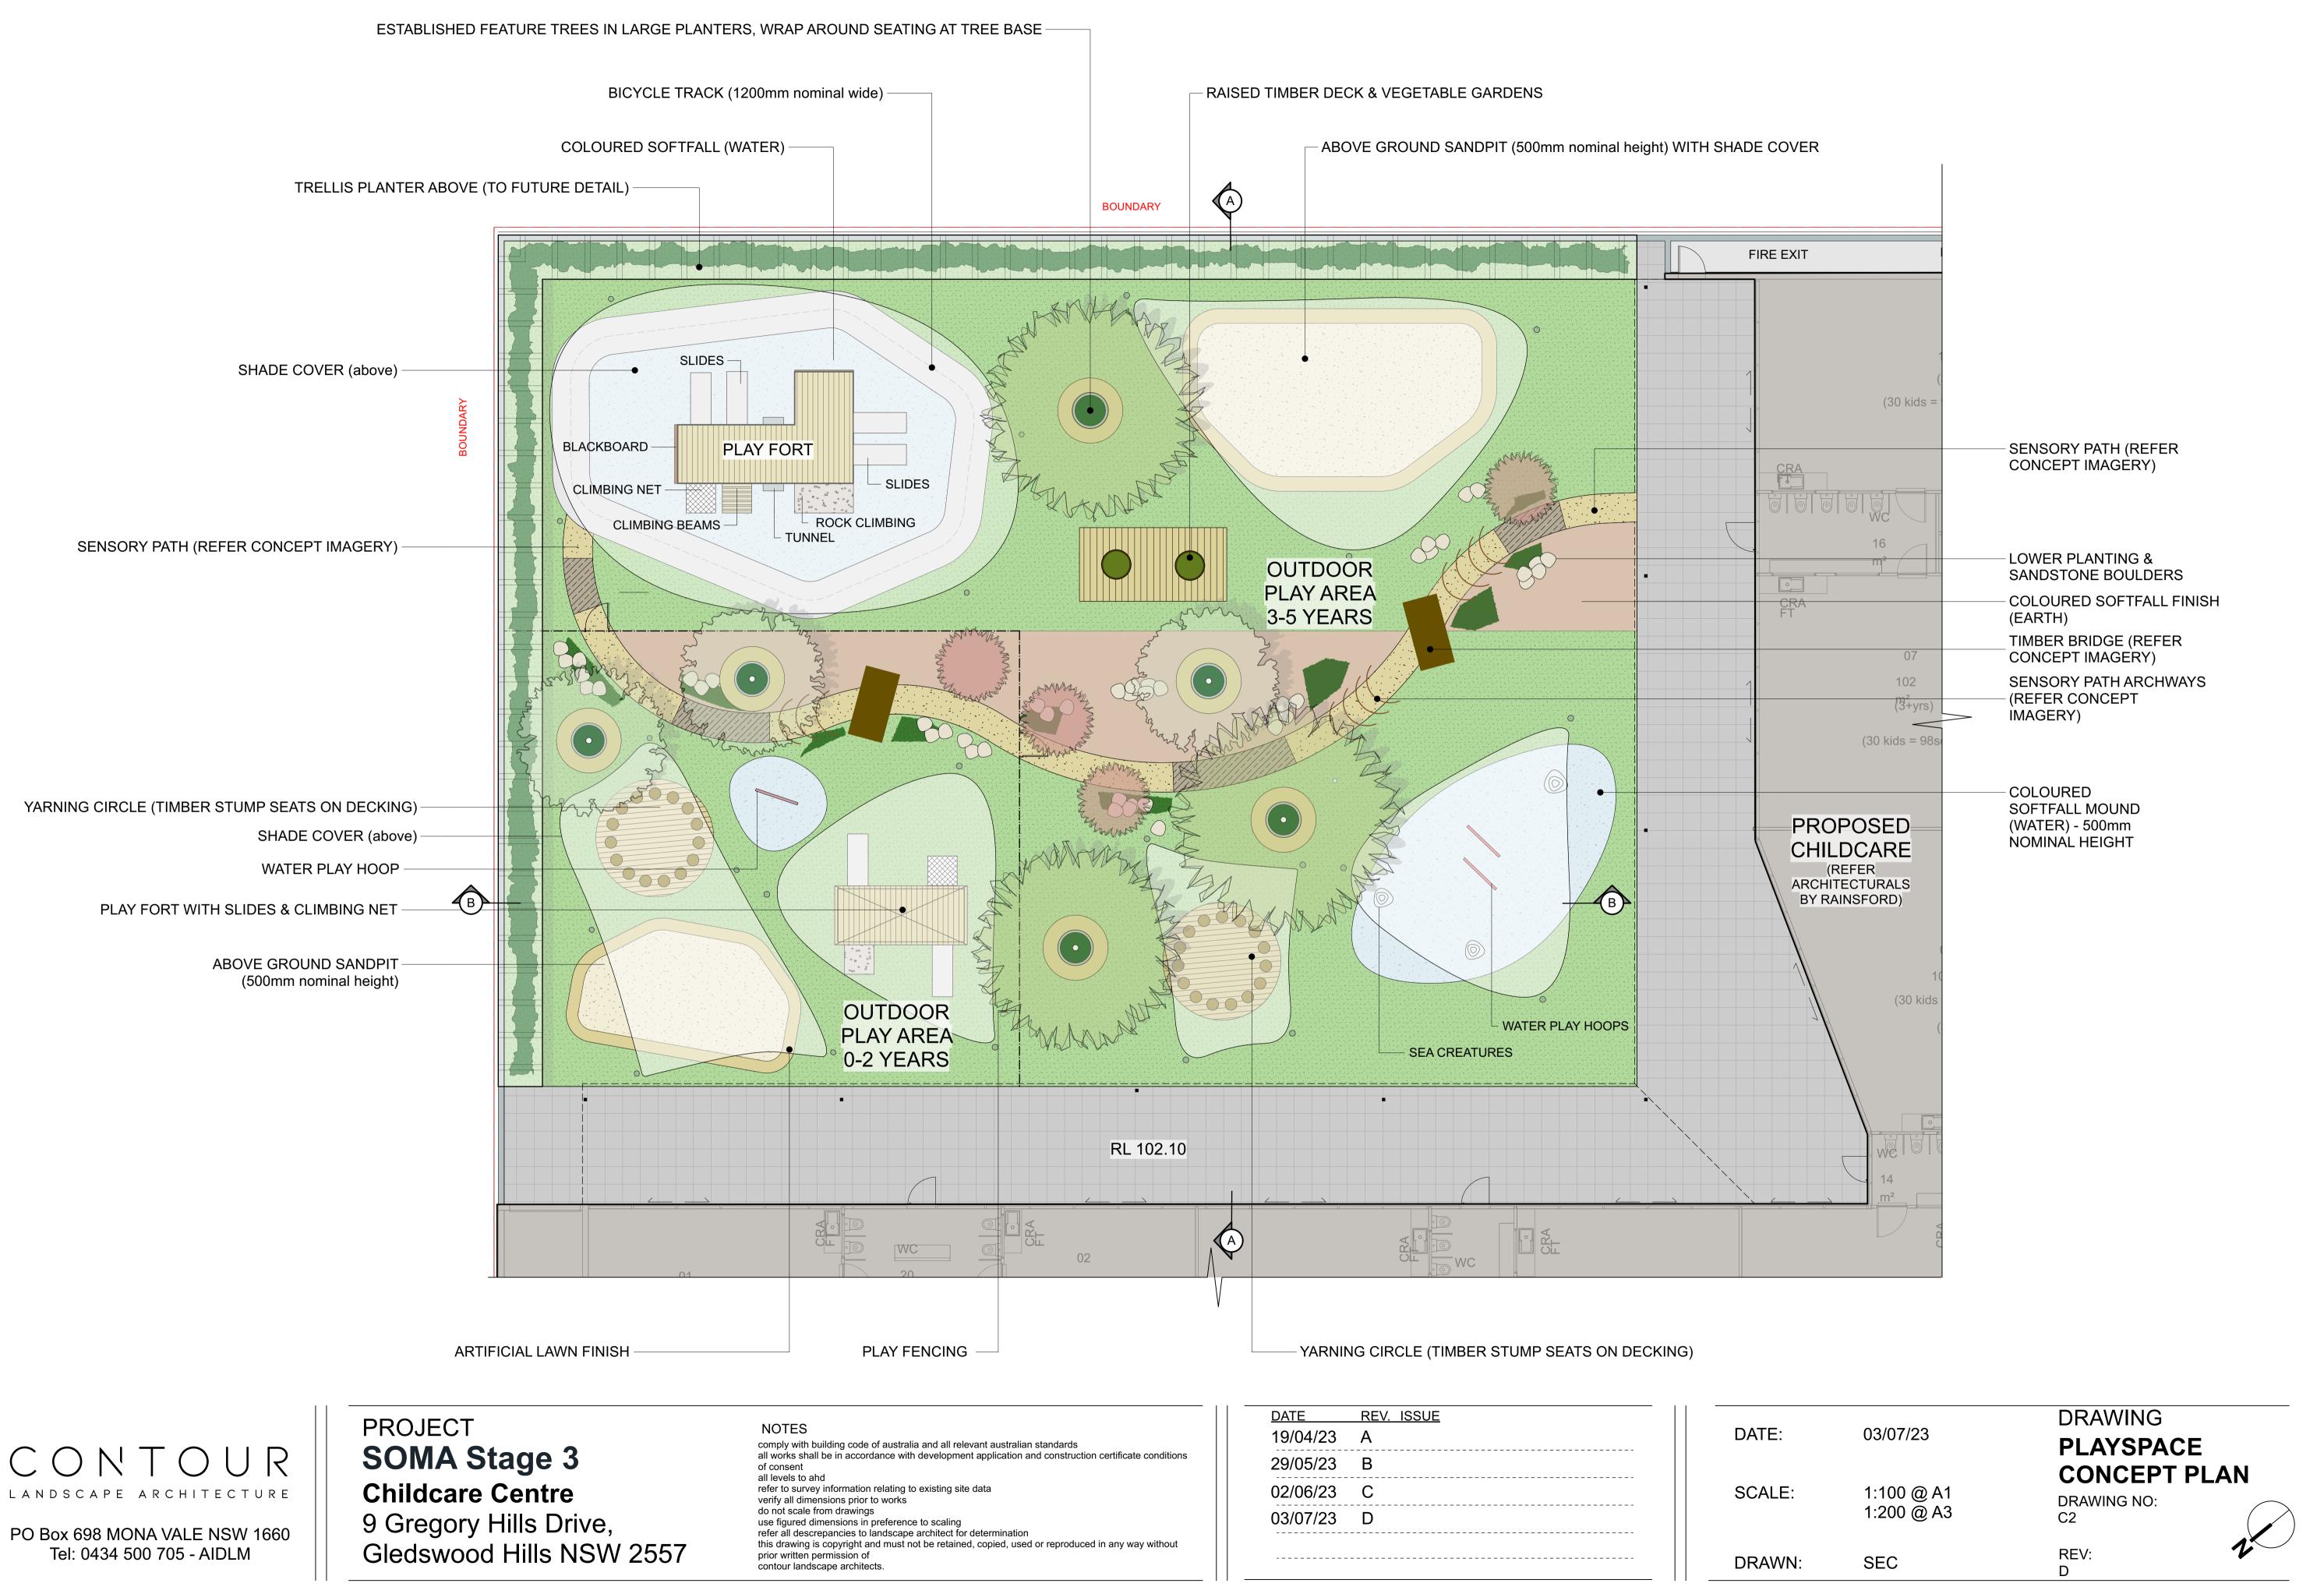






PROJECT SOMA Stage 3 Childcare Centre 9 Gregory Hills Drive, Gledswood Hills NSW 2557

NOTES NOTES comply with building code of australia and all relevant australian standards all works shall be in accordance with development application and construct of consent all levels to ahd refer to survey information relating to existing site data verify all dimensions prior to works do not scale from drawings use figured dimensions in preference to scaling refer all descrepancies to landscape architect for determination this drawing is copyright and must not be retained, copied, used or reproduce prior written permission of contour landscape architects. duced in any way with

DATE REV. ISSUE	
19/04/23 A	DATE
29/05/23 B	
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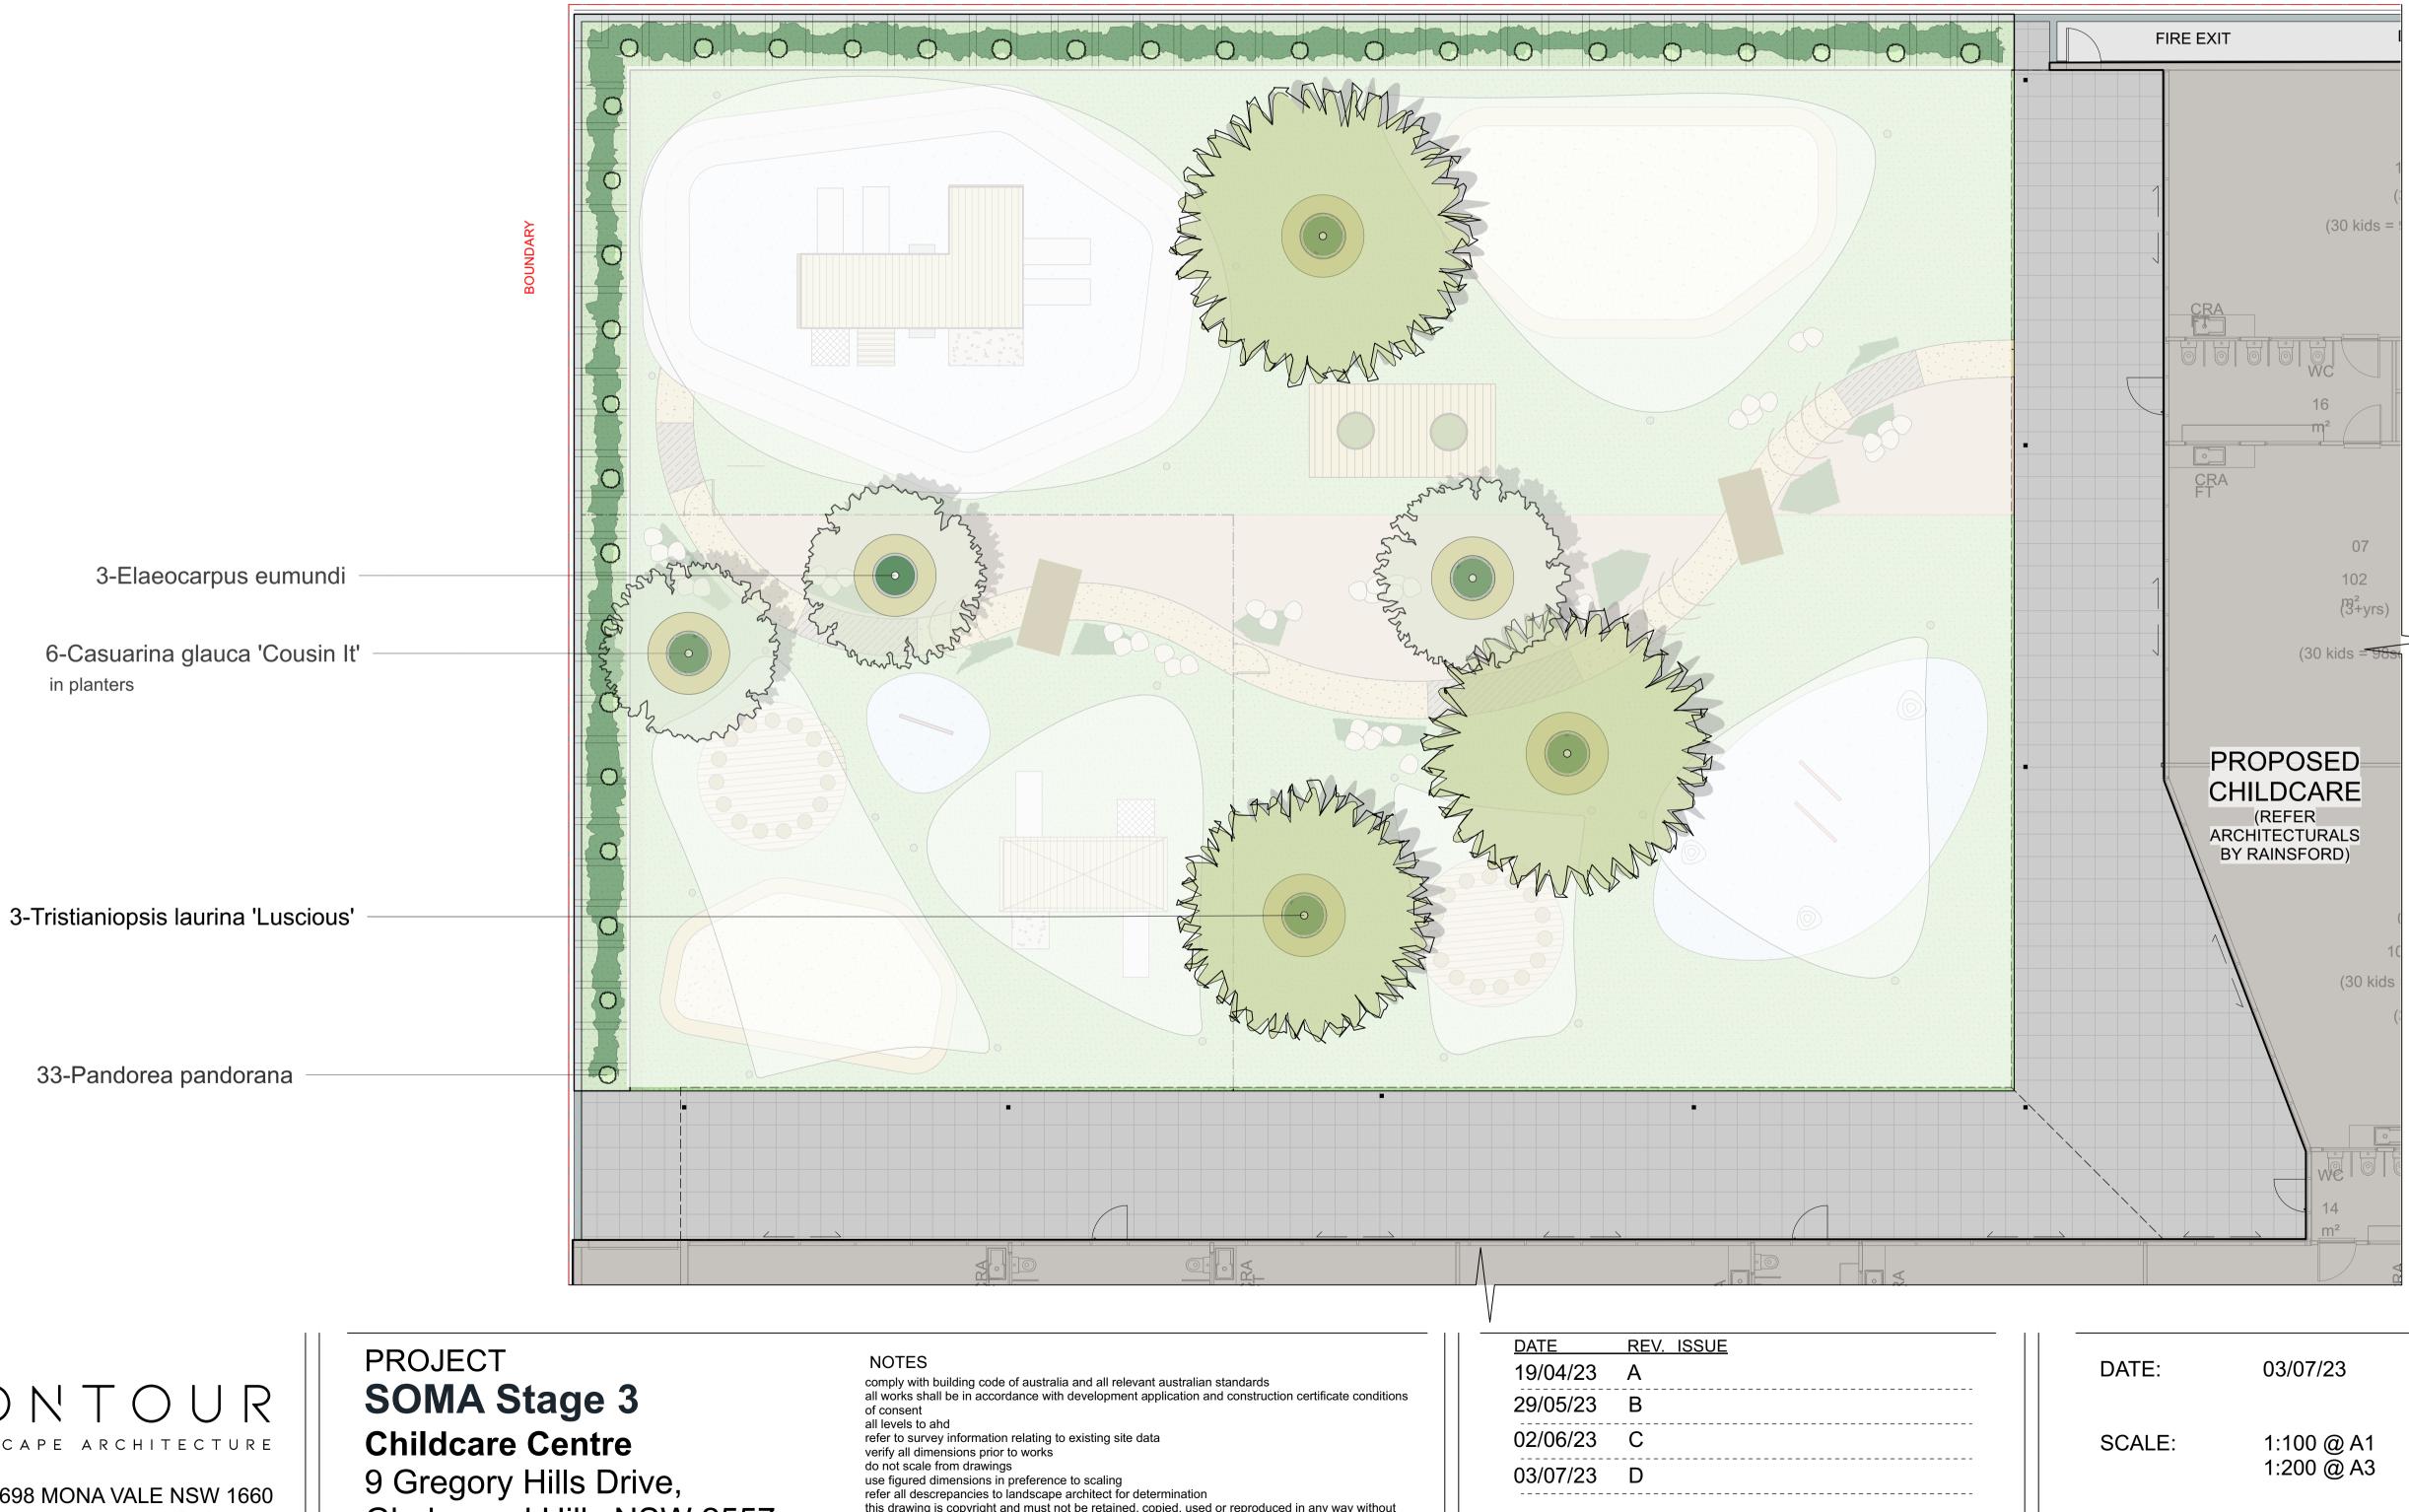
DRAWING E: 03/07/23 PLAYSPACE CONCEPT IMAGERY DRAWING NO: C3 LE: N/A REV: D WN: SEC

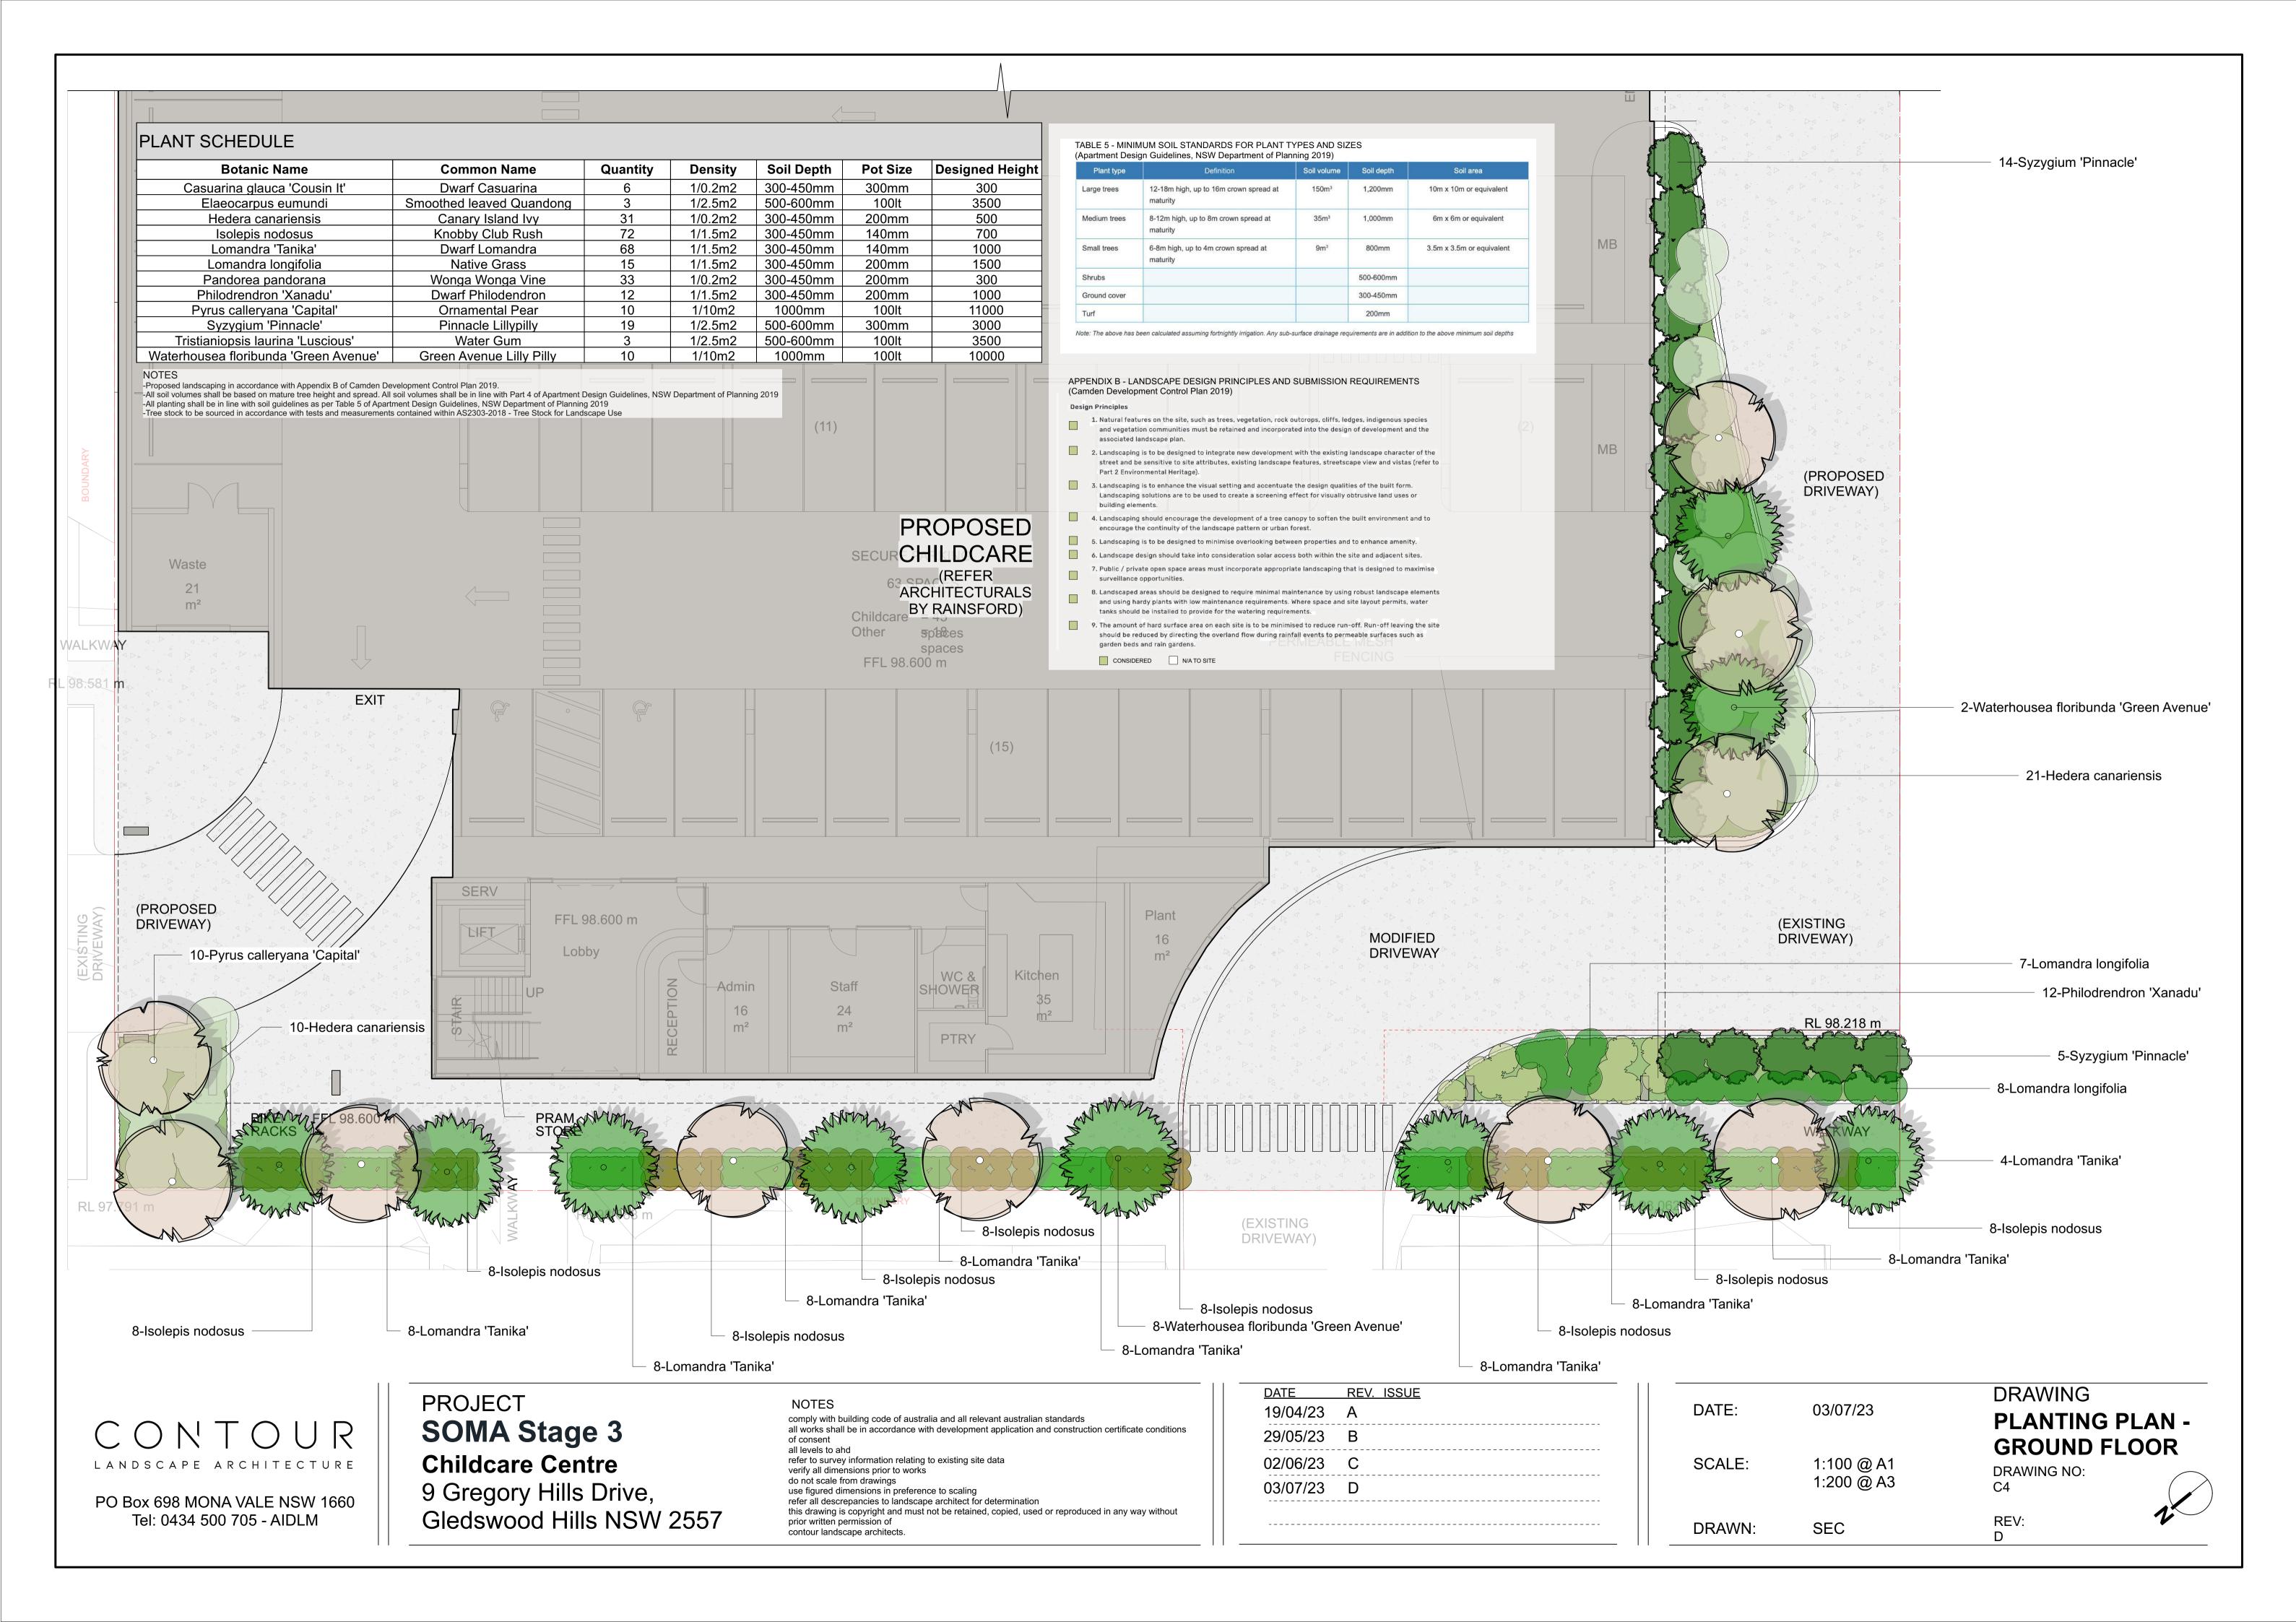

Botanic Name	Common Name	Quantity	Density	Soil Depth	Pot Size	Designed Height		IUM SOIL STANDARDS FOR PLANT T gn Guidelines, NSW Department of Plar		ZES	
Casuarina glauca 'Cousin It'	Dwarf Casuarina	6	1/0.2m2	300-450mm	300mm	300	Plant type	Definition	Soil volume	Soil depth	Soil area
Elaeocarpus eumundi	Smoothed leaved Quandong	3	1/2.5m2	500-600mm	100lt	3500	Large trees	12-18m high, up to 16m crown spread at	150m ³	1,200mm	10m x 10m or equivaler
Hedera canariensis	Canary Island Ivy	31	1/0.2m2	300-450mm	200mm	500		maturity	40503634		
Isolepis nodosus	Knobby Club Rush	72	1/1.5m2	300-450mm	140mm	700	Medium trees	8-12m high, up to 8m crown spread at	35m ³	1,000mm	6m x 6m or equivalen
Lomandra 'Tanika'	Dwarf Lomandra	68	1/1.5m2	300-450mm	140mm	1000	The second s	maturity	-5544		
Lomandra longifolia	Native Grass	15	1/1.5m2	300-450mm	200mm	1500	Small trees	6-8m high, up to 4m crown spread at	9m ³	800mm	3.5m x 3.5m or equivale
Pandorea pandorana	Wonga Wonga Vine	33	1/0.2m2	300-450mm	200mm	300	and and and a day in any information	maturity	Congrades.		
Philodrendron 'Xanadu'	Dwarf Philodendron	12	1/1.5m2	300-450mm	200mm	1000	Shrubs			500-600mm	
Pyrus calleryana 'Capital'	Ornamental Pear	10	1/10m2	1000mm	100lt	11000	Ground cover			300-450mm	
Syzygium 'Pinnacle'	Pinnacle Lillypilly	19	1/2.5m2	500-600mm	300mm	3000	Turf				
Tristianiopsis laurina 'Luscious'	Water Gum	3	1/2.5m2	500-600mm	100lt	3500	Turr			200mm	
aterhousea floribunda 'Green Avenue'	Green Avenue Lilly Pilly	10	1/10m2	1000mm	100lt	10000	Note: The above has t	een calculated assuming fortnightly irrigation. Any sub-	-surface drainage req	uirements are in addit	tion to the above minimum soil de

NOTES -Proposed landscaping in accordance with Appendix B of Camden Development Control Plan 2019.

-All soil volumes shall be based on mature tree height and spread. All soil volumes shall be in line with Part 4 of Apartment Design Guidelines, NSW Department of Planning 2019 -All planting shall be in line with soil guidelines as per Table 5 of Apartment Design Guidelines, NSW Department of Planning 2019 -Tree stock to be sourced in accordance with tests and measurements contained within AS2303-2018 - Tree Stock for Landscape Use



CONTOURLANDSCAPE ARCHITECTURE

PO Box 698 MONA VALE NSW 1660 Tel: 0434 500 705 - AIDLM

Gledswood Hills NSW 2557

BOUNDARY

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APPENDIX B - LANDSCAPE DESIGN PRINCIPLES AND SUBMISSION REQUIREMENTS (Camden Development Control Plan 2019)

1. Natural features on the site, such as trees, vegetation, rock outcrops, cliffs, ledges, indigenous species and vegetation communities must be retained. and vegetation communities must be retained and incorporated into the design of development and the associated landscape plan.

2. Landscaping is to be designed to integrate new development with the existing landscape character of the street and be sensitive to site attributes, existing landscape features, streetscape view and vistas (refer to Part 2 Environmental Heritage).

3. Landscaping is to enhance the visual setting and accentuate the design qualities of the built form. Landscaping solutions are to be used to create a screening effect for visually obtrusive land uses or building elements.

4. Landscaping should encourage the development of a tree canopy to soften the built environment and to encourage the continuity of the landscape pattern or urban forest.

5. Landscaping is to be designed to minimise overlooking between properties and to enhance amenity. 6. Landscape design should take into consideration solar access both within the site and adjacent sites. 7. Public / private open space areas must incorporate appropriate landscaping that is designed to maximise surveillance opportunities.


8. Landscaped areas should be designed to require minimal maintenance by using robust landscape elements and using hardy plants with low meintenance systematics and using hardy plants with low meintenance systematics and using hardy plants with low maintenance requirements. Where space and site layout permits, water tanks should be installed to provide for the watering requirements.

9. The amount of hard surface area on each site is to be minimised to reduce run-off. Run-off leaving the site should be reduced by directing the overland flow during rainfall events to permeable surfaces such as garden beds and rain gardens.

CONSIDERED N/A TO SITE

Design Principles

DATE:	03/07/23	DRAWING PLANTING PLAN
SCALE:	1:100 @ A1 1:200 @ A3	FIRST FLOOR DRAWING NO: C5
DRAWN:	SEC	REV:

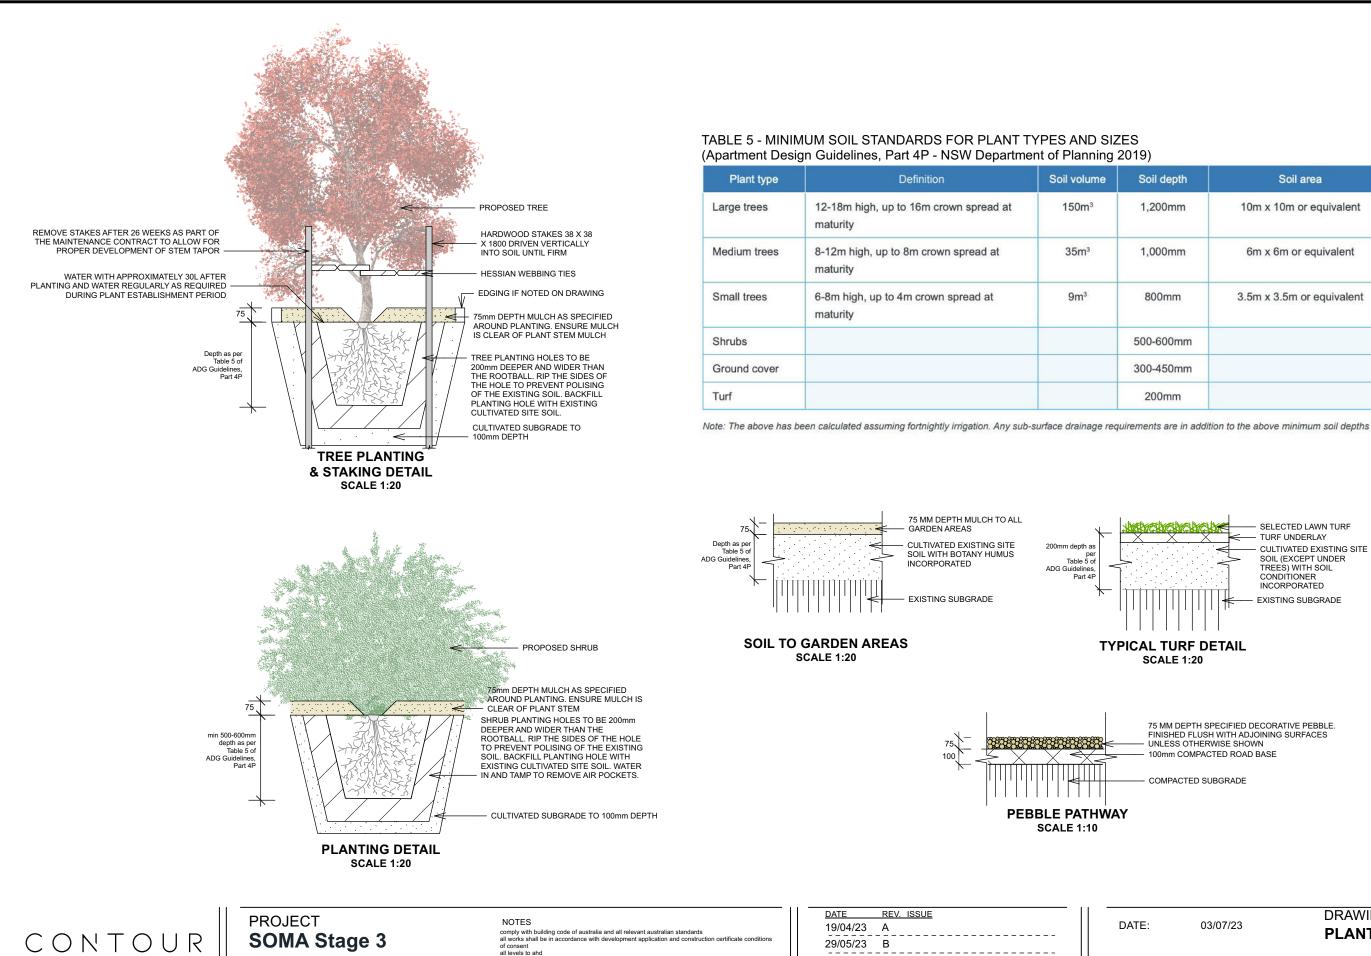

DATE	REV. ISSUE	
19/04/23	A	DATE:
29/05/23	В	
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03/07/23	D	
		DRAWN:

75

100

PO Box 698 MONA VALE NSW 1660 Tel: 0434 500 705 - AIDLM


LANDSCAPE ARCHITECTURE

SOMA Stage 3 Childcare Centre 9 Gregory Hills Drive,

Gledswood Hills NSW 2557

all works shall be in accordance with development appli of consent all levels to and refer to survey information relating to existing site data verify all dimensions prior to works do not scale from drawings use figured dimensions in preference to scaling refer all descrepancies to landscape architect for deterr this drawing is nearchited to work and he orbitand, and reter all descrepancies to landscape architect for determination this drawing is copyright and must not be retained, copied, used or reproduced in any way without prior written permission of contour landscape architects.

5	المراجع والمراجع	75 MM DEPTH MULCH TO ALL
er of s, P	×	CULTIVATED EXISTING SITE
\leftarrow		

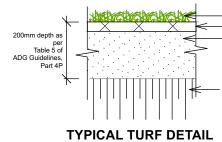

SCALE 1:20

Soil volume

150m³

35m³

9m³



 \triangleleft

PEBBLE PATHWAY

SCALE 1:10

Soil depth	Soil area
1,200mm	10m x 10m or equivalent
1,000mm	6m x 6m or equivalent
800mm	3.5m x 3.5m or equivalent
500-600mm	
300-450mm	
200mm	

SELECTED LAWN TURF TURF UNDERLAY CULTIVATED EXISTING SITE SOIL (EXCEPT UNDER TREES) WITH SOIL CONDITIONER INCORPORATED EXISTING SUBGRADE

75 MM DEPTH SPECIFIED DECORATIVE PEBBLE FINISHED FLUSH WITH ADJOINING SURFACES - UNLESS OTHERWISE SHOWN 100mm COMPACTED ROAD BASE

COMPACTED SUBGRADE

DRAWING **PLANTING DETAILS**

As stated @ A3

03/07/23

SEC

DRAWING NO: C6

VN:

REV: D





PROJECT SOMA Stage 3 **Childcare Centre** 9 Gregory Hills Drive, Gledswood Hills NSW 2557

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ABOVE GROUND SANDPIT (500mm nominal height) with SHADE COVER ABOVE -

<u>ate</u> 9/04/23	REV. ISSUE A	DATE:	03/07/23	DRAWING SECTION AA
9/05/23	В			OLUTION AA
)2/06/23	С	SCALE:	1:50 @ A1	DRAWING NO:
)3/07/23	D		1:100 @ A3	C7
		DRAWN:	SEC	REV: D





PROJECT SOMA Stage 3 **Childcare Centre** 9 Gregory Hills Drive, Gledswood Hills NSW 2557

NOTES comply with building code of australia and all relevant australian standards all works shall be in accordance with development application and construction certificate conditions


of consent all levels to ahd refer to survey information relating to existing site data verify all dimensions prior to works do not scale from drawings use figured dimensions in preference to scaling refer all descrepancies to landscape architect for determination this drawing is convict and must not be retained, consider used of

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29/05/23	A B				DATE:	03/07/23	DRAWIN	ON BE	3
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COLOURED SOFTFALL MOUND (500mm nominal height) - WATER

WATER PLAY HOOPS



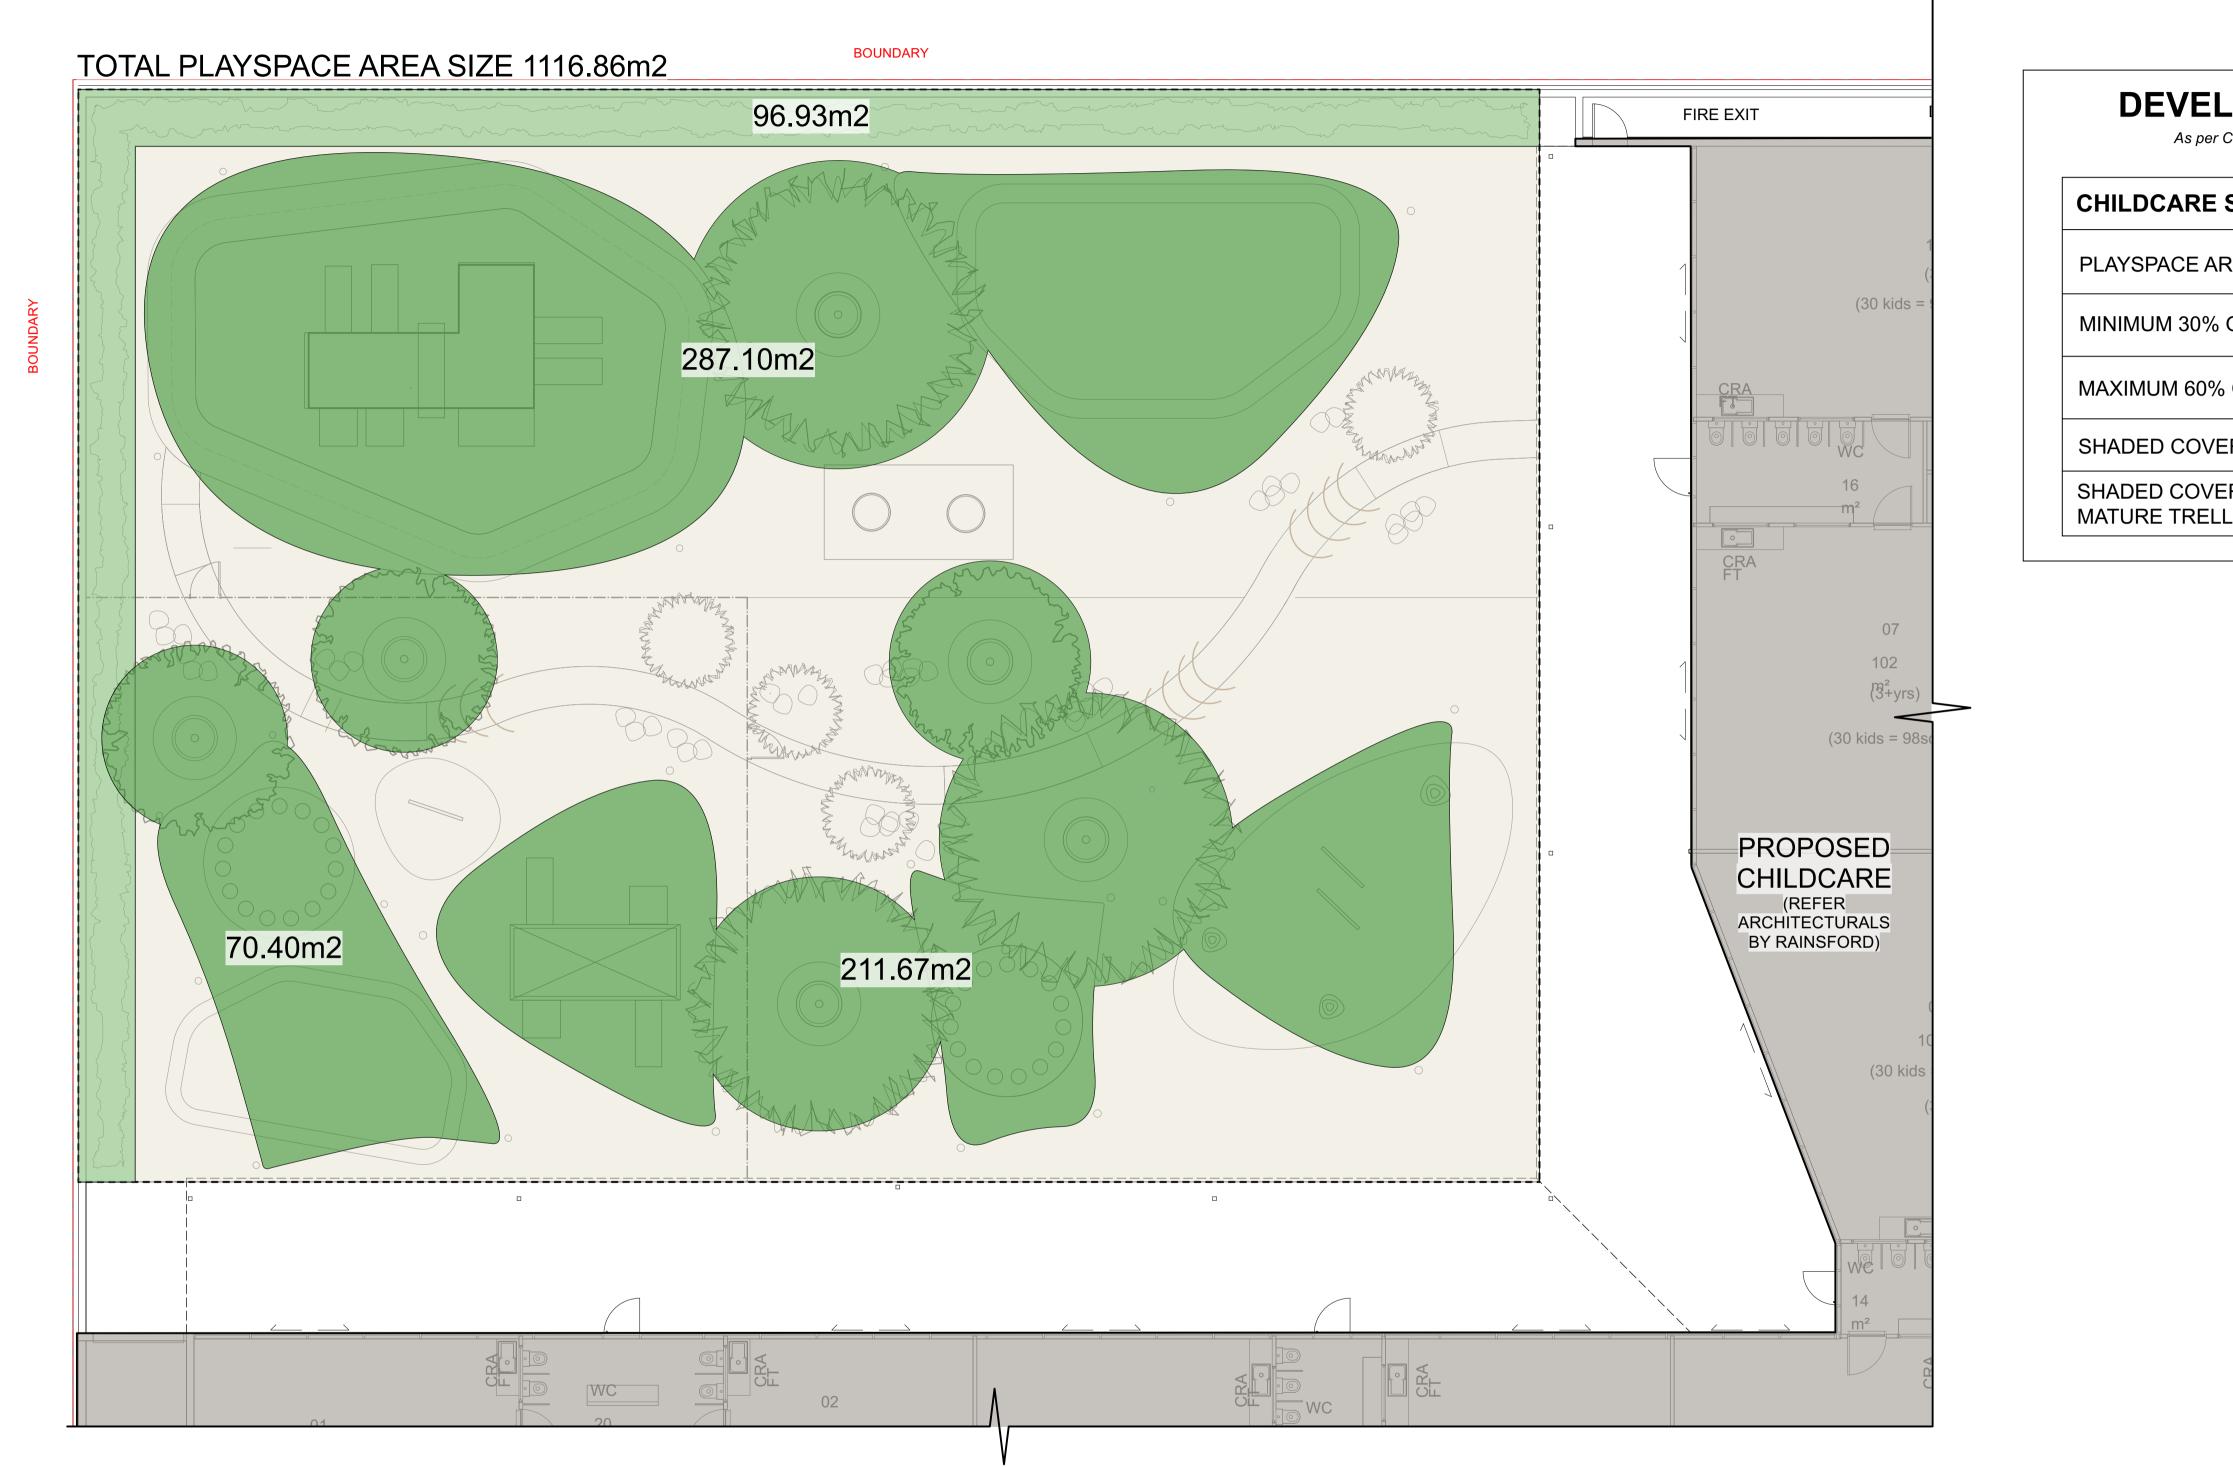

PROJECT SOMA Stage 3 **Childcare Centre** 9 Gregory Hills Drive, Gledswood Hills NSW 2557

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g code of australia and all relevant australian standards	
accordance with development application and construction ce	ertificate conditions

DATE	REV. ISSUE	
19/04/23	A	DATE
29/05/23	В	
02/06/23	С	SCAL
03/07/23	D	
12/12/23	E	
		DRAV

LOPMENT COMPLIANCE TABLE Childcare Planning Guidelines 2017, 4.11 Shade, Regulation 114 - Education & Care Services National Regulations						
SHADE COMPLIANCE AREA COMPLY						
REA SIZE	1116.86m2	N/A				
OF GROUND AREA	335.05m2	N/A				
6 COVERAGE	670.12m2	N/A				
ERAGE AT INSTALL	569.17m2	YES				
ERAGE INCLUDING	666.1m2	YES				

	40/40/00	DRAWING
	12/12/23	CHILDCARE SHADE
_		COMPLIANCE PLAN
.E:	1:100 @ A1 1:200 @ A3	DRAWING NO: C9
VN:	SEC	REV:



SOMA WELLNESS

8 GREGORY HILLS DRIVE GLEDSWOOD HILLS N.S.W. SOMA CHILDCARE CENTRE


DRAWING SCHEDULE

DRAWING NUMBER 230026-DA-C01.01 230026-DA-C01.11 230026-DA-C03.01 230026-DA-C03.21 230026-DA-C04.01 230026-DA-C05.01 230026-DA-C05.11 230026-DA-C11.01 230026-DA-C14.01 230026-DA-C14.02 230026-DA-C18.51 230026-DA-C20.01

DESCRIPTION

COVER SHEET & DRAWING SCHEDULE GENERAL NOTES AND LEGENDS BULK EARTHWORKS EROSION AND SEDIMENT CONTROL PLAN EROSION AND SEDIMENT CONTROL DETAILS CUT AND FILL PLAN SITEWORKS AND STORMWATER MANAGEMENT PLAN GROUND FLOOR LEVEL PODIUM AND ROOF PLAN PAVEMENT, SIGNAGE AND LINEMARKING PLAN SITEWORKS AND STORMWATER DETAILS - SHEET 01 SITEWORKS AND STORMWATER DETAILS - SHEET 02 ON-SITE DETENTION TANK PLAN AND DETAILS CATCHMENT PLAN

Scale	0 SCALE 1:1500	50	100	150m @A1	North	Enspire Solutions Pty Ltd
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SURVEY

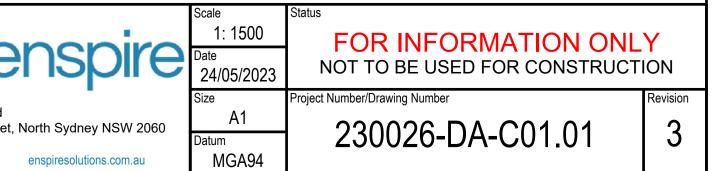- ORIGIN OF SURVEY
 - PROJECT: SSM/PM: RI ·

00045-99121 DATE: 21/07/2020 CARRIED OUT BY: JOHN LOWE AND ASSOCIATES PTY LTD 168905 102.29

- THE EXISTING SITE CONDITIONS SHOWN ON THE FOLLOWING DRAWINGS HAVE BEEN SUPPLIED BY REGISTERED SURVEYORS TO PROVIDE A BASIS FOR DESIGN. THE USE OF THIS SURVEY BASE DOES NOT GUARANTEE THE ACCURACY OR COMPLETENESS OF THE SURVEY BASE OR ITS SUITABILITY AS A BASIS FOR CONSTRUCTION DRAWINGS.
- SHOULD DISCREPANCIES BE ENCOUNTERED DURING CONSTRUCTION BETWEEN THE SURVEY DATA AND ACTUAL FIELD DATA, CONTACT THE SUPERINTENDENT.
- THE RELATIONSHIP OF IMPROVEMENTS TO BOUNDARIES ARE DIAGRAMMATIC ONLY. WHERE DISTANCES TO BOUNDARIES ARE CRITICAL THEY SHOULD BE CONFIRMED ON SITE PRIOR TO CONSTRUCTION BY FURTHER SURVEY.

GENERAL

- ALL WORKS TO BE CONSTRUCTED IN ACCORDANCE WITH CAMDEN COUNCIL STANDARDS.
- 2. CAMDEN COUNCIL STANDARD DETAILS TO BE USED WHERE POSSIBLE.
- 3. UTILITY ADJUSTMENTS AT DEVELOPERS EXPENSE.
- 4. CONDUITS TO BE PLACED WHERE REQUIRED BY THE RELEVANT AUTHORITIES.
- SUBSOIL DRAINAGE LINES AND FLUSHING POINTS AT MAXIMUM 60m CENTRES SHALL BE INSTALLED BEHIND ALL KERBS.
- . A MINIMUM OF 3m OF SUBSOIL LINE SHALL BE LAID INTO UPSTREAM SIDE OF ALL DRAINAGE PITS.

EXISTING UNDERGROUND SERVICES NOTES

THE LOCATIONS OF UNDERGROUND SERVICES SHOWN IN THIS SET OF DRAWINGS HAVE BEEN PLOTTED FROM SURVEY INFORMATION AND SERVICE AUTHORITY INFORMATION. THE SERVICE INFORMATION HAS BEEN PREPARED ONLY TO SHOW THE APPROXIMATE POSITIONS OF ANY KNOWN SERVICES AND MAY NOT BE AS CONSTRUCTED OR ACCURATE. ENSPIRE SOLUTIONS CAN NOT GUARANTEE THAT THE SERVICES INFORMATION SHOWN ON THESE DRAWINGS ACCURATELY INDICATES THE PRESENCE OR ABSENCE OF SERVICES OR THEIR LOCATION AND WILL ACCEPT NO LIABILITY FOR INACCURACIES IN THE SERVICES INFORMATION SHOWN FROM ANY CAUSE WHATSOEVER.

CONTRACTORS SHALL TAKE DUE CARE WHEN EXCAVATING ONSITE INCLUDING HAND EXCAVATION WHERE NECESSARY. CONTRACTORS ARE TO CONTACT THE RELEVANT SERVICE AUTHORITY PRIOR TO COMMENCEMENT OF EXCAVATION WORKS, CONTRACTORS ARE TO UNDERTAKE A SERVICES SEARCH. PRIOR TO COMMENCEMENT OF WORKS ON SITE. SEARCH RESULTS ARE TO BE KEPT ON SITE AT ALL TIMES.

COMMUNICATIONS- DUTY OF CARE NOTE

COMMUNICATIONS AND DATA PROVIDER PLANS SHOW ONLY THE PRESENCE OF CABLES AND PLANT. THEY ONLY SHOW THEIR POSITION RELATIVE TO ROAD BOUNDARIES, PROPERTY FENCES ETC. AT THE TIME OF INSTALLATION AND EACH PROVIDER DOES NOT WARRANT OR HOLD OUT THAT SUCH PLANS ARE ACCURATE THEREAFTER DUE TO CHANGES THAT MAY OCCUR OVER TIME. DO NOT ASSUME DEPTH OR ALIGNMENT OF CABLES OR PLANT AS THESE VARY SIGNIFICANTLY. THE CONTRACTOR HAS A DUTY OF CARE WHEN EXCAVATING NEAR COMMUNICATIONS AND DATA CABLES AND PLANT. BEFORE USING MACHINE EXCAVATORS COMMUNICATIONS PLANT MUST FIRST BE PHYSICALLY EXPOSED BY SOFT DIG POTHOLING TO IDENTIFY IT'S LOCATION,

PROVIDERS WILL SEEK COMPENSATION FOR DAMAGES CAUSED TO IT'S PROPERTY AND LOSSES CAUSED TO THE PROVIDERS AND IT'S CUSTOMERS.

TELSTRA - DUTY OF CARE NOTE

TELSTRA'S PLANS SHOW ONLY THE PRESENCE OF CABLES AND PLANT. THEY ONLY SHOW THEIR POSITION RELATIVE TO ROAD BOUNDARIES, PROPERTY FENCES ETC. AT THE TIME OF INSTALLATION AND TELSTRA DOES NOT WARRANT OR HOLD OUT THAT SUCH PLANS ARE ACCURATE THEREAFTER DUE TO CHANGES THAT MAY OCCUR OVER TIME. DO NOT ASSUME DEPTH OR ALIGNMENT OF CABLES OR PLANT AS THESE VARY SIGNIFICANTLY. THE CONTRACTOR HAS A DUTY OF CARE WHEN EXCAVATING NEAR TELSTRA CABLES AND PLANT.

BEFORE USING MACHINE EXCAVATORS TELSTRA PLANT MUST FIRST BE PHYSICALLY EXPOSED BY SOFT DIG POTHOLING TO IDENTIFY IT'S LOCATION TELSTRA WILL SEEK COMPENSATION FOR DAMAGES CAUSED TO IT'S PROPERTY AND LOSSES CAUSED TO TELSTRA AND IT'S CUSTOMERS.

EROSION AND SEDIMENT CONTROL

GENERAL INSTRUCTIONS

- . THE CONTRACTOR SHALL BE SOLELY RESPONSIBLE FOR THE CONTROL OF EROSION AND SEDIMENTATION TO THE SATISFACTION OF COUNCIL, NSW OFFICE OF WATER, DEPARTMENT OF PLANNING, INDUSTRY AND ENVIRONMENT. THE EROSION AND SEDIMENTATION CONTROLS SHOWN ON THE DRAWINGS SHALL ONLY BE USED AS A GUIDE BY THE CONTRACTOR. AND SHALL REPRESENT THE MINIMUM REQUIREMENT ONLY.
- 2. THE CONTRACTOR SHALL ENSURE THAT ALL SOIL AND WATER MANAGEMENT WORKS ARE LOCATED TO SUIT CONSTRUCTION STAGING AND WORK PRACTICES OR AS OTHERWISE DIRECTED BY THE SUPERINTENDENT. ALL WORK SHALL BE GENERALLY CARRIED OUT IN ACCORDANCE WITH
- a. LOCAL AUTHORITY REQUIREMENTS b. EPA REQUIREMENTS c. LANDCOM MANUAL "MANAGING URBAN STORMWATER, SOILS AND
- CONSTRUCTION", 4th EDITION, MARCH 2004.
- MAINTAIN THE EROSION CONTROL DEVICES TO THE SATISFACTION OF THE SUPERINTENDENT AND THE LOCAL AUTHORITY.
- WHEN STORMWATER PITS ARE CONSTRUCTED, PREVENT SITE RUNOFF ENTERING UNLESS SEDIMENT FENCES ARE ERECTED AROUND PITS.
- CONTRACTOR IS TO ENSURE ALL EROSION & SEDIMENT CONTROL DEVICES ARE MAINTAINED IN GOOD WORKING ORDER AND OPERATE EFFECTIVELY. REPAIRS AND OR MAINTENANCE SHALL BE UNDERTAKEN AS REQUIRED, PARTICULARLY FOLLOWING STORM EVENTS.

LAND DISTURBANCE

- WHERE PRACTICAL. THE SOIL EROSION HAZARD ON THE SITE WILL BE KEPT AS LOW AS POSSIBLE. TO THIS END, WORKS SHOULD BE UNDERTAKEN IN THE FOLLOWING SEQUENCE:
- a. INSTALL A SEDIMENT FENCE ALONG THE BOUNDARIES AS SHOWN ON PLAN. REFER DETAIL.
- b. CONSTRUCT STABILISED CONSTRUCTION ENTRANCE TO LOCATION AS DETERMINED BY SUPERINTENDENT/ENGINEER. REFER DETAIL.
- c. INSTALL SEDIMENT BASIN AS SHOWN ON PLAN. INSTALL SEDIMENT TRAPS AS SHOWN ON PLAN.
- d. UNDERTAKEN SITE DEVELOPMENT WORKS IN ACCORDANCE WITH THE ENGINEERING PLANS. WHERE POSSIBLE, PHASE DEVELOPMENT SO THAT LAND DISTURBANCE IS CONFINED TO AREAS OF WORKABLE SIZE.

EROSION CONTROL

- DURING WINDY WEATHER, LARGE, UNPROTECTED AREAS WILL BE KEPT MOIST (NOT WET) BY SPRINKLING WITH WATER TO KEEP DUST UNDER CONTROL.
- FINAL SITE LANDSCAPING WILL BE UNDERTAKEN AS SOON AS POSSIBLE AND WITHIN 20 WORKING DAYS FROM COMPLETION OF CONSTRUCTION ACTIVITIES.

SEDIMENT CONTROL

9. STOCKPILES WILL NOT BE LOCATED WITHIN 2 METRES OF HAZARD AREAS, INCLUDING LIKELY AREAS OF CONCENTRATED OR HIGH VELOCITY FLOWS SUCH AS WATERWAYS. WHERE THEY ARE BETWEEN 2 AND 5 METRES FROM SUCH AREAS, SPECIAL SEDIMENT CONTROL MEASURES SHOULD BE TAKEN TO MINIMISE POSSIBLE POLLUTION TO DOWNSTREAM WATERS, E.G. THROUGH INSTALLATION OF SEDIMENT FENCING.

- 10. ANY SAND USED IN THE CONCRETE CURING PROCESS (SPREAD OVER THE SURFACE) WILL BE REMOVED AS SOON AS POSSIBLE AND WITHIN 10 WORKING DAYS FROM PLACEMENT.
- 11. WATER WILL BE PREVENTED FROM ENTERING THE PERMANENT DRAINAGE SYSTEM UNLESS IT IS RELATIVELY SEDIMENT FREE, I.E. THE CATCHMENT AREA HAS BEEN PERMANENTLY LANDSCAPED AND/OR ANY LIKELY SEDIMENT HAS BEEN FILTERED THROUGH AN APPROVED STRUCTURE.
- 12. TEMPORARY SOIL AND WATER MANAGEMENT STRUCTURES WILL BE REMOVED ONLY AFTER THE LANDS THEY ARE PROTECTING ARE REHABILITATED.
- 13. ACCEPTABLE RECEPTORS WILL BE PROVIDED FOR CONCRETE AND MORTAR SLURRIES, PAINTS, ACID WASHINGS, LIGHT-WEIGHT WASTE MATERIALS AND LITTER.
- 14. ANY EXISTING TREES WHICH FORM PART OF THE FINAL LANDSCAPING PLAN WILL BE PROTECTED FROM CONSTRUCTION ACTIVITIES IN ACCORDANCE WITH SECTION 4 OF AS4970 "PROTECTION OF TREES ON DEVELOPMENT SITES" AND COUNCIL CONSENT CONDITIONS.

- APPROVAL.

LOCATION **UNDER BUI** LANDSCAPE ROADS & PA

- UNDER ROAD OTHER AREA

Α. В. C.

- ACHIEVED.
- GROUND.
- Α.
- В. C.



								Client	Scale
								SOMA	
	3	20/11/2023	ISSUED FOR DEVELOPMENT APPLICATION	NAF	AD	MKH	MKH	WELLNESS	
	2	1/09/2023	ISSUED FOR DEVELOPMENT APPLICATION	CB	EZ	MKH	MKH		
	1	24/05/2023	ISSUED FOR COORDINATION	NPH	EBO		MHO		The c
Į	REV.	DATE	DESCRIPTION	DRN.	DES.	VERIF.	APPD.		witho
_									

EARTHWORKS

1. AT THE COMMENCEMENT OF THE CUT AND FILLING OPERATIONS FOR BULK EARTHWORKS A GEOTECHNICAL ENGINEER IS TO VISIT THE SITE & CONFIRM THE SUITABILITY OF THE METHODOLOGY OF ACHIEVING THE REQUIRED BUILDING PLATFORMS AND COMPACTION REQUIREMENTS. SUBSEQUENTLY, THE HEAD CONTRACTOR IS TO CONFIRM, IN WRITING TO THE SUPERINTENDENT THAT THE METHODOLOGY APPROVED AT THE TIME OF THE GEOTECHNICAL ENGINEERS VISIT WAS MAINTAINED DURING ALL THE BULK EARTHWORKS PROCESS.

2. STRIP TOPSOIL, ORGANIC MATTER AND RUBBLE FROM CONSTRUCTION AREA TO EXPOSE NATURALLY OCCURRING MATERIAL AND STOCKPILE ON SITE AS DIRECTED BY THE SUPERINTENDENT.

. WHERE FILLING, STRUCTURAL SLABS OR PAVEMENTS ARE REQUIRED, PROOF ROLL THE EXPOSED NATURAL SURFACE WITH A MINIMUM OF TEN PASSES OF A SMOOTH DRUM NON-VIBRATING ROLLER (MINIMUM STATIC WEIGHT OF 10 TONNES) TO DETECT THEN REMOVE SOFT SPOTS (AREAS WITH MORE THAN 2mm MOVEMENT UNDER ROLLER) IN THE PRESENCE OF THE SUPERINTENDENT. THE CONTRACTOR IS TO ALLOW TO REMOVE AND REPLACE A PROVISIONAL QUANTITY OF UNSUITABLE SUBGRADE MATTER.

4. ALL SOFT, WET OR UNSUITABLE MATERIAL IS TO BE REMOVED AS DIRECTED BY THE SUPERINTENDENT AND REPLACED WITH APPROVED MATERIAL SATISFYING THE REQUIREMENTS LISTED BELOW.

5. EXCAVATED MATERIAL IS NOT TO BE USED AS STRUCTURAL FILL UNLESS APPROVED BY THE GEOTECHNICAL ENGINEER.

6. THE CONTRACTOR IS TO PROVIDE CERTIFICATES VERIFYING THE QUALITY OF IMPORTED MATERIAL FOR THE SUPERINTENDENTS

. ALL FILL MATERIAL SHALL BE PLACED IN MAXIMUM LAYER THICKNESS TO COUNCIL SPECIFICATIONS AND COMPACTED AT OPTIMUM MOISTURE CONTENT (+ OR - 2%) TO ACHIEVE A DRY DENSITY DETERMINED IN ACCORDANCE WITH AS1289 E3.1 OF NOT LESS THAN THE FOLLOWING STANDARD MINIMUM DRY DENSITY IN ACCORDANCE WITH AS1289 E5.1.1.1

	COMPACTION REQUIREMENT
ILDING SLABS	98% SMDD
ED AREAS	95% SMDD
AVED AREAS	100% SMDD

3. FOR NON COHESIVE MATERIAL, COMPACT TO NOT LESS THAN 80% DENSITY 75% DENSITY

9. THE CONTRACTOR IS TO ALLOW FOR COMPACTION TESTING BY NATA REGISTERED LABORATORY FOR PLATFORMS AND FILL LAYERS IN ACCORDANCE WITH THE LATEST VERSION OF AS3798 - FOR TYPE 1 OPERATIONS (MINIMUM 3 TESTS PER LAYER).

10. FREQUENCY OF COMPACTION TESTING SHALL NOT BE LESS THAN: 1 TEST PER 200m³ OF FILL PLACED PER LAYER OF FILL **3 TESTS PER VISIT** 1 TEST PER 1000m² OF EXPOSED SUBGRADE

11. TESTING SHALL BE "LEVEL 1" UNDERTAKEN IN ACCORDANCE WITH AS 3798.

12. WHERE TEST RESULTS ARE BELOW THE SPECIFIED COMPACTION, RECOMPACT AND RETEST UNTIL SPECIFIED COMPACTION STANDARD IS

13. ALLOW FOR EXCAVATION IN ALL MATERIALS AS FOUND U.N.O. NO ADDITIONAL PAYMENTS WILL BE MADE FOR EXCAVATION IN WET OR HARD

14. WHERE THERE IS INSUFFICIENT EXCAVATED MATERIAL SUITABLE FOR FILLING OR SUBGRADE REPLACEMENT. THE CONTRACTOR IS TO ALLOW TO IMPORT FILL. IMPORTED FILL SHALL COMPLY WITH THE FOLLOWING: MAXIMUM SIZE 50mm. PASSING 75 MICRON SIEVE (<25%). PLASTICITY INDEX BETWEEN 2-15% AND CBR>8. FREE FROM ORGANIC AND PERISHABLE MATTER.

15. REFER TO THE SITE SPECIFIC GEOTECHNICAL REPORT FOR GENERAL REQUIREMENTS ON SITE PREPARATION AND RE-USE OF EXISTING SITE MATERIAL AS ENGINEERED FILL.

16. THE CONTRACTOR SHALL PROGRAM THE EARTHWORKS OPERATION SO THAT THE WORKING AREAS ARE ADEQUATELY DRAINED DURING THE PERIOD OF CONSTRUCTION. THE SURFACE SHALL BE GRADED AND SEALED OFF TO REMOVE DEPRESSIONS, ROLLER MARKS AND SIMILAR WHICH WOULD ALLOW WATER TO POND AND PENETRATE THE UNDERLYING MATERIAL. ANY DAMAGE RESULTING FROM THE CONTRACTOR NOT OBSERVING THESE REQUIREMENTS SHALL BE RECTIFIED AT THEIR COST.

17. IT IS THE RESPONSIBILITY OF THE CONTRACTOR TO ENSURE AND MAINTAIN THE INTEGRITY OF ALL SERVICES, CONDUITS AND PIPES DURING CONSTRUCTION, SPECIFICALLY DURING THE BACKFILLING AND COMPACTION PROCEDURE. ANY AND ALL DAMAGE TO NEW OR EXISTING SERVICES AS A RESULT OF THESE WORKS SHALL BE REPAIRED BY THE CONTRACTOR AT NO EXTRA COST.

18. PROTECT FINAL SURFACE WITH EITHER A TEMPORARY LOOSE SOIL LAYER OR A GRANULAR SUB-BASE LAYER TO PREVENT DRYING OUT PRIOR TO ON-GROUND SLAB CONSTRUCTION.



STORMWATER DRAINAGE NOTES

- STORMWATER DESIGN CRITERIA: (A) ANNUAL EXCEEDANCE PROBABILITIES (AEP): MINOR (PIPED) NETWORK 10% (1 IN 10) 1% (1 IN 100) MAJOR (OVERLAND FLOW) SYSTEM
- (B) RAINFALL INTENSITIES: ARR 2016 RAINFALL FROM BUREAU OF METEOROLOGY WEBSITE.
- (C) HYDROLOGIC METHOD: DRAINS
- PIPES 375 DIA. AND LARGER TO BE REINFORCED CONCRETE CLASS '2' APPROVED SPIGOT AND SOCKET WITH RUBBER RING JOINTS, U.N.O.
- PIPES 300 DIA AND LESS SHALL BE DWV GRADE (CLASS SN8) uPVC WITH SOLVENT WELDED JOINTS.
- ALL PIPES ARE TO BE UNIFORMLY SUPPORTED ALONG THE LENGTH OF THE BARREL BY SUITABLE FILL MATERIAL. REFER TO BEDDING SUPPORT TYPE.
- PIPES WITH SOCKETS SHALL BE LAID IN BEDDING WHERE SUITABLE RECESSES HAVE BEEN PROVIDED TO ENSURE PIPES DO NOT BEAR ON THEIR SOCKETS.
- ALL STORMWATER DRAINAGE LINES UNDER PROPOSED BUILDING SLABS TO BE uPVC PRESSURE PIPE PN6. ENSURE ALL VERTICALS AND DOWNPIPES ARE uPVC PRESSURE PIPE, GRADE 6 FOR A MIN OF 3.0m IN HEIGHT.
- PIPES TO BE INSTALLED TO TYPE HS2 SUPPORT IN ACCORDANCE WITH AS 3725 IN ALL CASES BACKFILL TRENCH WITH SAND TO 300mm ABOVE PIPE. WHERE PIPE IS UNDER PAVEMENTS BACKFILL REMAINDER OF TRENCH TO UNDERSIDE OF PAVEMENT WITH SAND OR APPROVED GRANULAR MATERIAL COMPACTED IN 150mm LAYERS TO MINIMUM 98% STANDARD MAXIMUM DRY DENSITY IN ACCORDANCE WITH AS 1289 5.2.1. (OR A DENSITY INDEX OF NOT LESS THAN 75).
- REFER TO AS/NRS 3725 TABLE B1 FOR REQUIRED FILL DEPTHS ABOVE PIPE BARREL PRIOR TO USE OF COMPACTION MACHINERY OR TRAVERSING OF PIPES BY GENERAL SITE EQUIPMENT.
- WHERE WORKING METHODS REQUIRE HIGHER CLASS PIPE, THE CONTRACTOR SHALL REFER TO AS 3725 TO DETERMINE THE APPROPRIATE PIPE CLASS. PROPOSED PIPE CLASS SHALL BE SUBMITTED TO THE SUPERINTENDENT FOR APPROVAL PRIOR TO INSTALLATION.
- 10. ALL INTERNAL WORKS WITHIN PROPERTY BOUNDARIES ARE TO COMPLY WITH THE REQUIREMENTS OF AS/NZS 3500.3.
- 1. PRECAST PITS MAY BE USED EXTERNAL TO THE BUILDING SUBJECT TO APPROVAL BY THE SUPERINTENDENT.
- 12. ENLARGERS, CONNECTIONS AND JUNCTIONS TO BE PREFABRICATED FITTINGS WHERE PIPES ARE LESS THAN 300 DIA.
- 13. SUBSOIL DRAINAGE LINES SHALL BE INSTALLED BEHIND ALL KERBS EXCEPT WHERE STORMWATER DRAINAGE IS LOCATED ALONG THE KERBLINE.
- 14. A MINIMUM OF 3m OF SUBSOIL LINE SHALL BE LAID INTO UPSTREAM SIDE OF ALL DRAINAGE PITS.
- 15. FLUSHING POINTS SHALL BE INSTALLED TO COUNCIL SPECIFICATION.
- 16. WHERE SUBSOIL DRAINS PASS UNDER FLOOR SLABS AND VEHICULAR PAVEMENTS, UNSLOTTED uPVC PRESSURE PIPE PN6 IS TO BE USED.
- 17. CARE IS TO BE TAKEN WITH LEVELS OF STORMWATER LINES. GRADES SHOWN ARE NOT TO BE REDUCED WITHOUT APPROVAL.
- 18. GRATES AND COVERS SHALL CONFORM TO AS 3996.
- 19. ALL BOX CULVERTS SHALL BE STRUCTURALLY DESIGNED BY THE MANUFACTURER AND DELIVERED TO SITE AS FIT FOR PURPOSE.
- 20. AT ALL TIMES DURING CONSTRUCTION OF STORMWATER PITS, ADEQUATE SAFETY PROCEDURES SHALL BE TAKEN TO ENSURE AGAINST THE POSSIBILITY OF PERSONNEL FALLING DOWN PITS.
- 21. ALL EXISTING STORMWATER DRAINAGE LINES AND PITS THAT ARE TO REMAIN ARE TO BE INSPECTED AND CLEANED. DURING THIS PROCESS ANY PART OF THE STORMWATER DRAINAGE SYSTEM THAT WARRANTS REPAIR SHALL BE REPORTED TO THE SUPERINTENDENT/ENGINEER FOR FURTHER DIRECTIONS.

KERBS

- 1. ALL KERBS, GUTTERS, DISH DRAINS AND CROSSINGS TO BE CONSTRUCTED ON 175mm GRANULAR BASECOURSE COMPACTED TO MINIMUM 95% MODIFIED DRY DENSITY (AS 1289 5.2.1).
- 2. EXPANSION JOINTS (E.J) TO BE FORMED FROM 10mm COMPRESSIBLE FOAM FILLER BOARD FOR THE FULL DEPTH OF THE SECTION AND CUT TO PROFILE. EXPANSION JOINTS TO BE LOCATED AT DRAINAGE PITS, ON TANGENT POINTS OF CURVES AND ELSEWHERE AS SPECIFIED BY COUNCIL EXCEPT FOR INTEGRAL KERBS WHERE THE EXPANSION JOINTS ARE TO MATCH THE JOINT LOCATIONS IN THE SLABS.
- 3. WEAKENED PLANE JOINTS TO BE MIN 3mm WIDE AND LOCATED AS SPECIFIED BY COUNCIL EXCEPT FOR INTEGRAL KERBS WHERE THE WEAKENED PLANE JOINTS ARE TO MATCH THE JOINT LOCATIONS IN THE SLABS.
- 4. EXISTING ALLOTMENT DRAINAGE PIPES ARE TO BE BUILT INTO THE NEW KERB AND GUTTER WITH 100mm DIA HOLE OR IN ACCORDANCE WITH LOCAL AUTHORITY REQUIREMENTS.
- 5. IN THE REPLACEMENT OF KERB AND GUTTER : EXISTING ROAD PAVEMENT IS TO BE SAWCUT 600mm U.N.O FROM THE LIP OF GUTTER. UPON COMPLETION OF THE NEW KERB AND GUTTER NEW BASECOURSE AND SURFACE TO BE LAID 600mm WIDE U.N.O.

PAVEMENT JOINTS

- PEDESTRIAN PAVEMENTS 1. ALL PEDESTRIAN PAVEMENTS ARE TO BE JOINTED AS FOLLOWS U.N.O ON THE DESIGN DRAWINGS
- 2. EXPANSION JOINTS ARE TO BE LOCATED WHERE POSSIBLE AT TANGENT POINTS OF CURVES AND ELSEWHERE AT MAX. 6.0m CENTRES.
- 3. WEAKENED PLANE JOINTS ARE TO BE LOCATED AT A MAX. SPACING OF 1.5 x WIDTH OF THE PAVEMENT.
- 4. WHERE POSSIBLE JOINTS SHOULD BE LOCATED TO MATCH KERBING AND OR ADJACENT PAVEMENT JOINTS.
- 5. TYPICAL PEDESTRIAN PAVEMENT JOINT DETAIL.

E		WPJ	ЦЧМ	,
				1.5 x W
	-		6m MAX	-

VEHICULAR PAVEMENTS

- 6. ALL VEHICULAR PAVEMENTS TO BE JOINTED AS FOLLOWS U.N.O ON THE DESIGN DRAWINGS.
- 7. TIED KEYED CONSTRUCTION JOINTS SHOULD GENERALLY BE LOCATED LONGITUDINALLY AT A MAX OF 6.0m CENTRES
- 8. SAWN JOINTS SHOULD GENERALLY BE LOCATED LATERALLY AT A MAX OF
- 9. TYPICAL VEHICULAR PAVEMENT JOINT DETAIL.

DEJ	SJ	KJ KJ	DEJ
		KJ	
	-	6m MAX 18m MAX	ſ
1			

- 10. PROVIDE 10mm EXPANSION FOAM BETWEEN NEW CONCRETE WORKS AND EXISTING STRUCTURES.
- 11. LOCAL AUTHORITY REQUIREMENTS SHALL TAKE PRECEDENCE WITHIN THE PUBLIC ROAD RESERVE.
- 12. DOWELS TO BE PLACED ON PROPRIETARY CRADLES TO ENSURE CORRECT SPACING AND ALIGNMENT.

le	North	Enspire Solutions Pty Ltd	Project 8 GREGORY HILLS DRIVE GLEDSWOOD HILLS N.S.W. SOMA CHILDCARE CENTRE Title GENERAL NOTES AND LEGE
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6.0m CENTRES WITH DOWELED EXPANSION JOINTS AT MAX 18.0m CENTRES

Ś	
	6m MAX


ASPHALTIC CONCRETE

- ALL ASPHALTIC CONCRETE (AC) WORK TO BE PREPARED AND CARRIED OUT IN ACCORDANCE WITH GOOD ASPHALTIC PAVING PRACTICE AS DESCRIBED IN AS2734 "ASPHALT (HOT-MIXED) PAVING - GUIDE TO GOOD PRACTICE" AND CURRENT THNSW SPECIFICATIONS. 2. PAVEMENT PREPARATION
- A) THE EXISTING SURFACE TO BE SEALED SHALL BE WITHIN +/- 2% OF THE OPTIMUM AND BROOMED BEFORE COMMENCEMENT OF WORK TO ENSURE COMPLETE REMOVAL OF ALL SUPERFICIAL FOREIGN MATTER.
- B) PRIME ALL SURFACES TO BE SEALED. ALLOW PRIME TO SETTLE FOR A MINIMUM OF 3 DAYS BEFORE APPLYING TACK COAT AND ASPHALT
- C) SWEEP PRIMED SURFACES BEFORE APPLYING TACK COAT D) ALL DEPRESSIONS OR UNEVEN AREAS ARE TO BE TACK-COATED AND BROUGHT UP TO GENERAL LEVEL OF PAVEMENT WITH ASPHALTIC CONCRETE BEFORE LAYING OF MAIN COURSE.
- E) ALL DEFECTS IN THE BASE COURSE INCLUDING CRACKS. SURFACE DEFORMATION AND THE LIKE SHALL BE REPAIRED AS DIRECTED BY THE SUPERINTENDENT PRIOR TO PLACEMENT OF TACK COAT AND/OR AC COURSES.
- PLACEMENT
- ALL ASPHALT SHALL BE PLACED UTILISING APPROVED MECHANICAL PAVING MACHINES, DO NOT HAND PLACE ASPHALT WITHOUT PRIOR APPROVAL FROM ENGINEER.
- JOINTS
- A) THE NUMBER OF JOINTS BOTH LONGITUDINAL AND TRANSVERSE SHALL BE KEPT TO A MINIMUM.
- B) THE DENSITY AND SURFACE FINISH AT JOINTS SHALL BE SIMILAR TO THOSE OF THE REMAINDER OF THE LAYER.
- COMPACTION
- A) ALL COMPACTION SHALL BE UNDERTAKEN USING SELF PROPELLED ROLLERS.
- B) INITIAL ROLLING SHALL BE COMPLETED BEFORE THE MIX TEMPERATURE FALLS BELOW 105°C USING A STEEL DRUM ROLLER HAVING A MINIMUM WEIGHT OF 8 TONNES AND A MAXIMUM UNIT LOAD ON THE REAR DRUM EQUIVALENT TO 55kN/m WIDTH OF DRUM.
- C) SECONDARY ROLLING SHALL BE COMPLETED BEFORE THE MIX TEMPERATURE FALLS BELOW 80°C USING A PNEUMATIC TYRED ROLLER OF AT LEAST 10 TONNES MASS, A MINIMUM TYRE PRESSURE OF 550kPa AND A MINIMUM TOTAL LOAD OF 1 TONNE ON EACH TYRE.
- D) ROLLED SURFACES SHALL BE SMOOTH AND FREE OF UNDULATIONS. BONY AND UNEVEN SURFACES WILL BE REJECTED.
- E) PROVIDE 2 No. MINIMUM COMPACTION TESTS.
- FINISHED SURFACE PROPERTIES FINISHED SURFACES SHALL BE SMOOTH, DENSE AND TRUE TO SHAPE AND SHALL NOT VARY MORE THAN:
- A) 3mm FROM THE SPECIFIED PLAN LEVEL AT ANY POINT. B) 3mm FROM THE BOTTOM OF A 3m STRAIGHT EDGE LAID TRANSVERSELY
- C) 5mm FROM THE BOTTOM OF A 3m STRAIGHT EDGE LAID LONGITUDINALLY
- D) MINUS 0 TO PLUS 2mm ADJACENT TO OTHER ELEMENTS SUCH AS KERBS AND THE LIKE TO AVOID POOLING OF SURFACE WATER. E) MINUS 0 FROM THE SPECIFIED THICKNESS.
- DO NOT STORE PLANT EQUIPMENT OR TRAFFIC NEWLY LAID ASPHALTIC
- CONCRETE PAVEMENTS WITHOUT PRIOR APPROVAL FROM THE ENGINEER.
- 3. DO NOT APPLY MARKING PAINTS UNTIL ASPHALT HAS CURED IN ACCORDANCE WITH PAINT MANUFACTURER'S SPECIFICATIONS.

SIGNAGE AND LINE MARKING

- . LINE MARKING AND PAINT SHALL BE IN ACCORDANCE WITH AS 2700 AND AS 4049 AND TRNSW SPECIFICATIONS.
- 2. ALL PAINT SHALL BE APPLIED BY MECHANICAL SPRAYER.
- 3. LINE MARKING SHALL BE SPOTTED OUT AND APPROVED PRIOR TO SPRAYING.
- PAINT SHALL BE APPLIED AT A WET THICKNESS OF BETWEEN 0.35mm TO 0.40mm.
- TRANSITION LINEMARKING TO SUIT EXISTING WHERE REQUIRED.ALL SIGNAGE TO BE INSTALLED IN ACCORDANCE WITH AUSTRALIAN STANDARDS.
- 6. REMOVE ALL REDUNDANT PAVEMENT MARKING AS REQUIRED.
- PROVIDE RETRO-REFLECTORISED PAVEMENT MARKERS TO COUNCIL AND TfNSW. REQUIREMENTS.
- 8. ALL LINEMARKING TO BE WHITE IN COLOUR WITH THE EXCEPTION OF C2 AND C3 LINES ARE TO BE YELLOW.
- 9. CARPARK LINEMARKING PAINT SHALL BE TYPE 3, CLASS A, AND THE COLOUR SHALL BE WHITE AND NOT DISCOLOURED BY BITUMEN. EACH LINE SHALL BE 80mm WIDE.
- 10. ALL SIGNAGE TO BE IN ACCORDANCE WITH THE CURRENT VERSION OF THE TINSW. REGULATORY SIGNS MANUAL.
- 11. RELOCATE OR REMOVE EXISTING SIGNS AS REQUIRED.
- 12. PROVIDE ADEQUATE APPROACH WARNING SIGNS DURING AND AFTER CONSTRUCTION.

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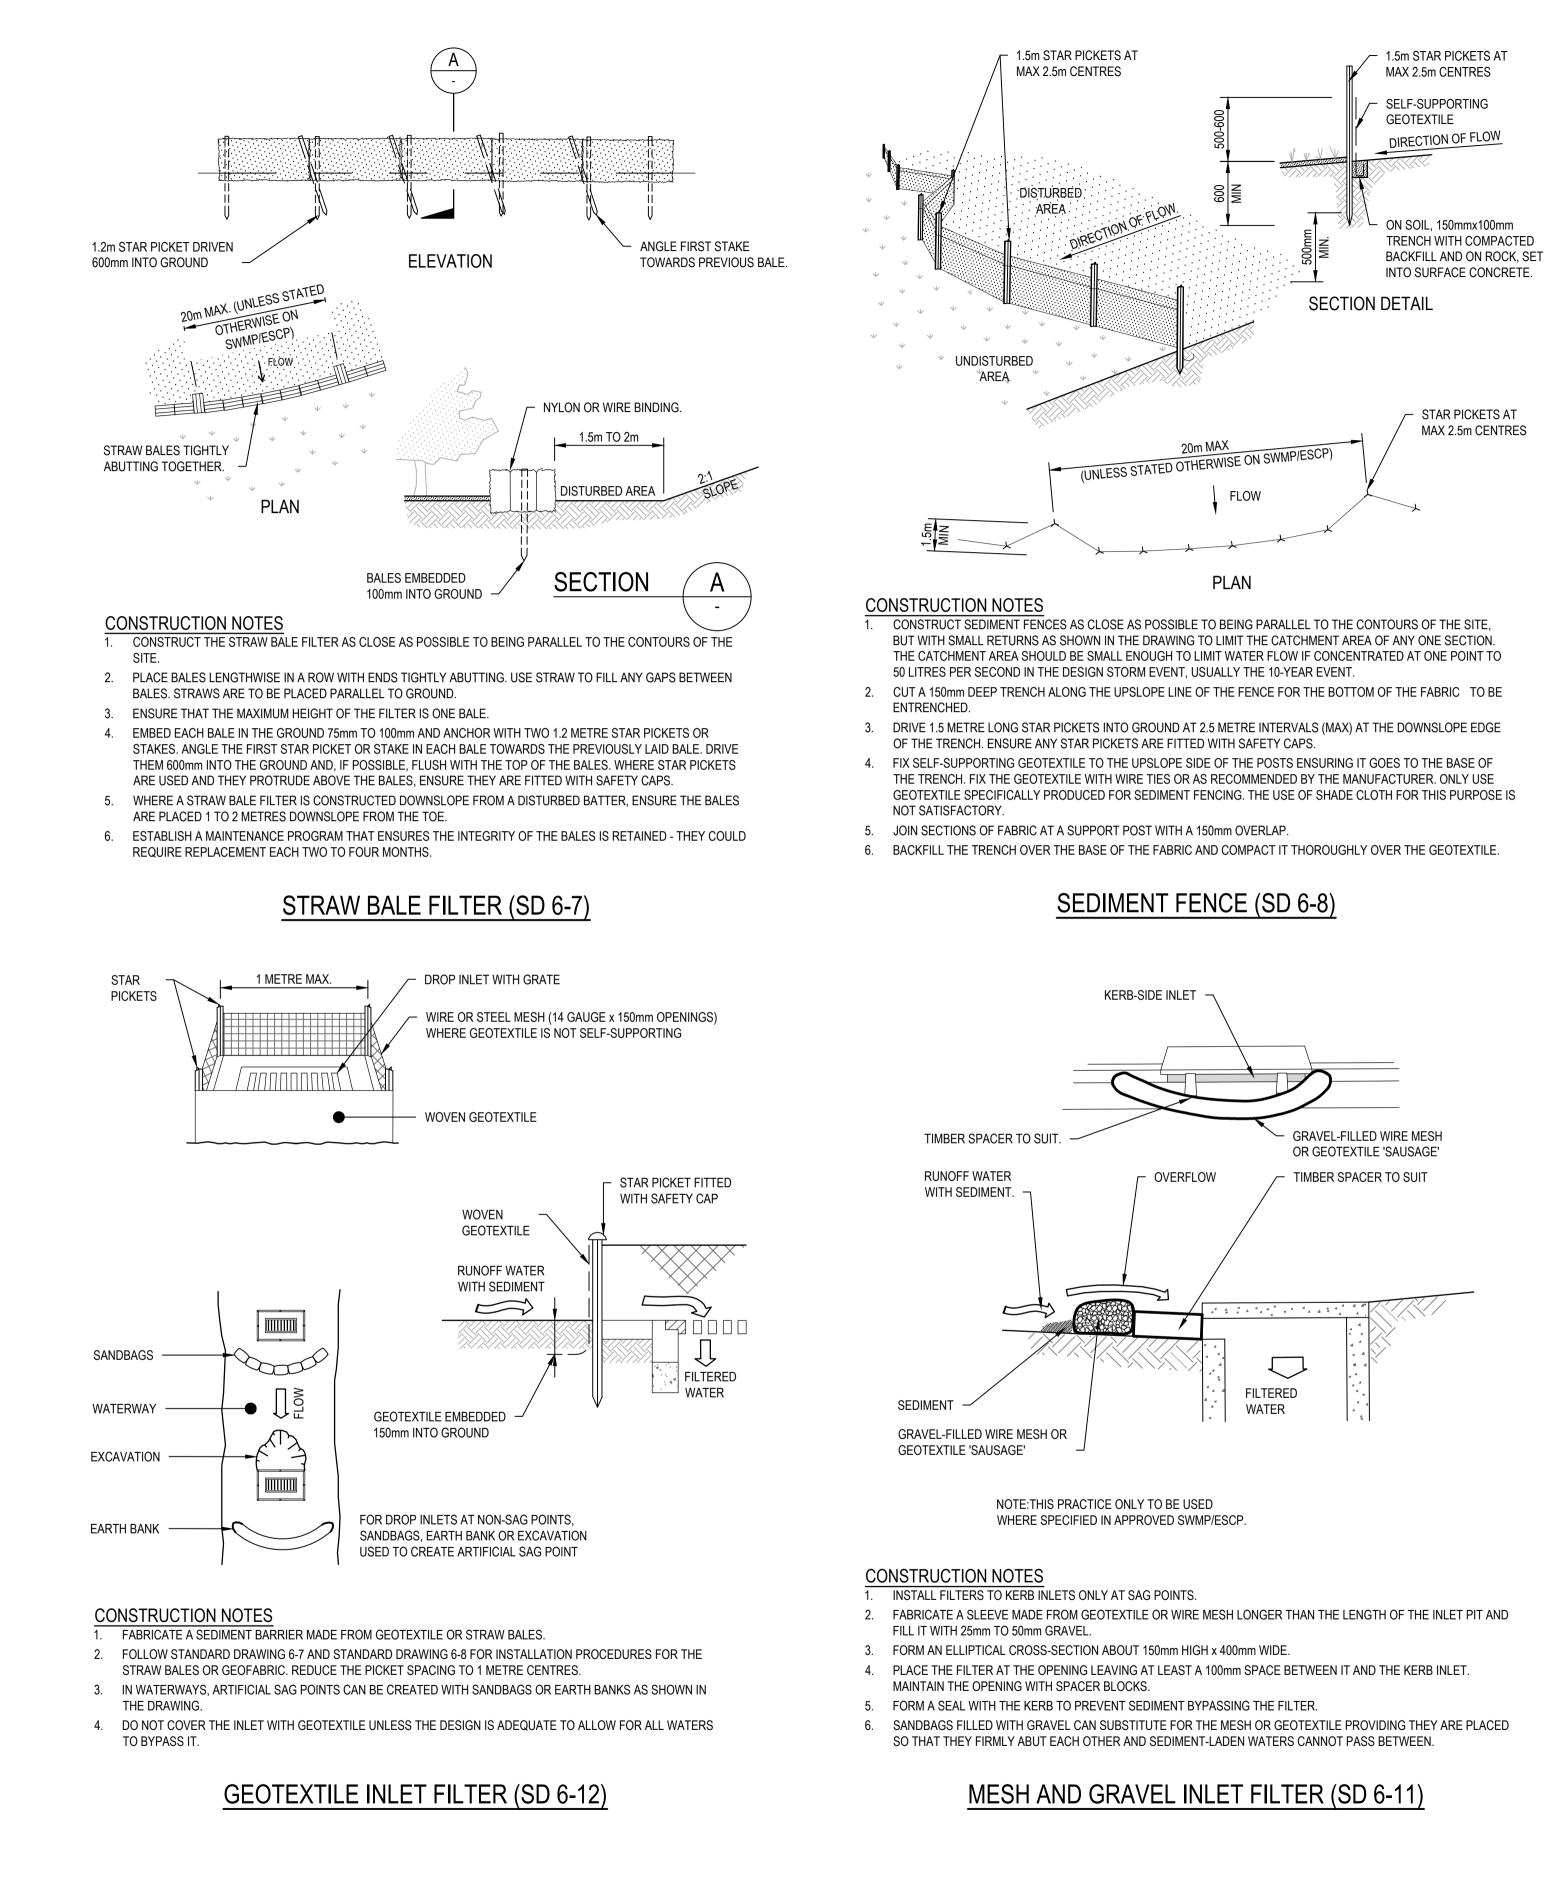

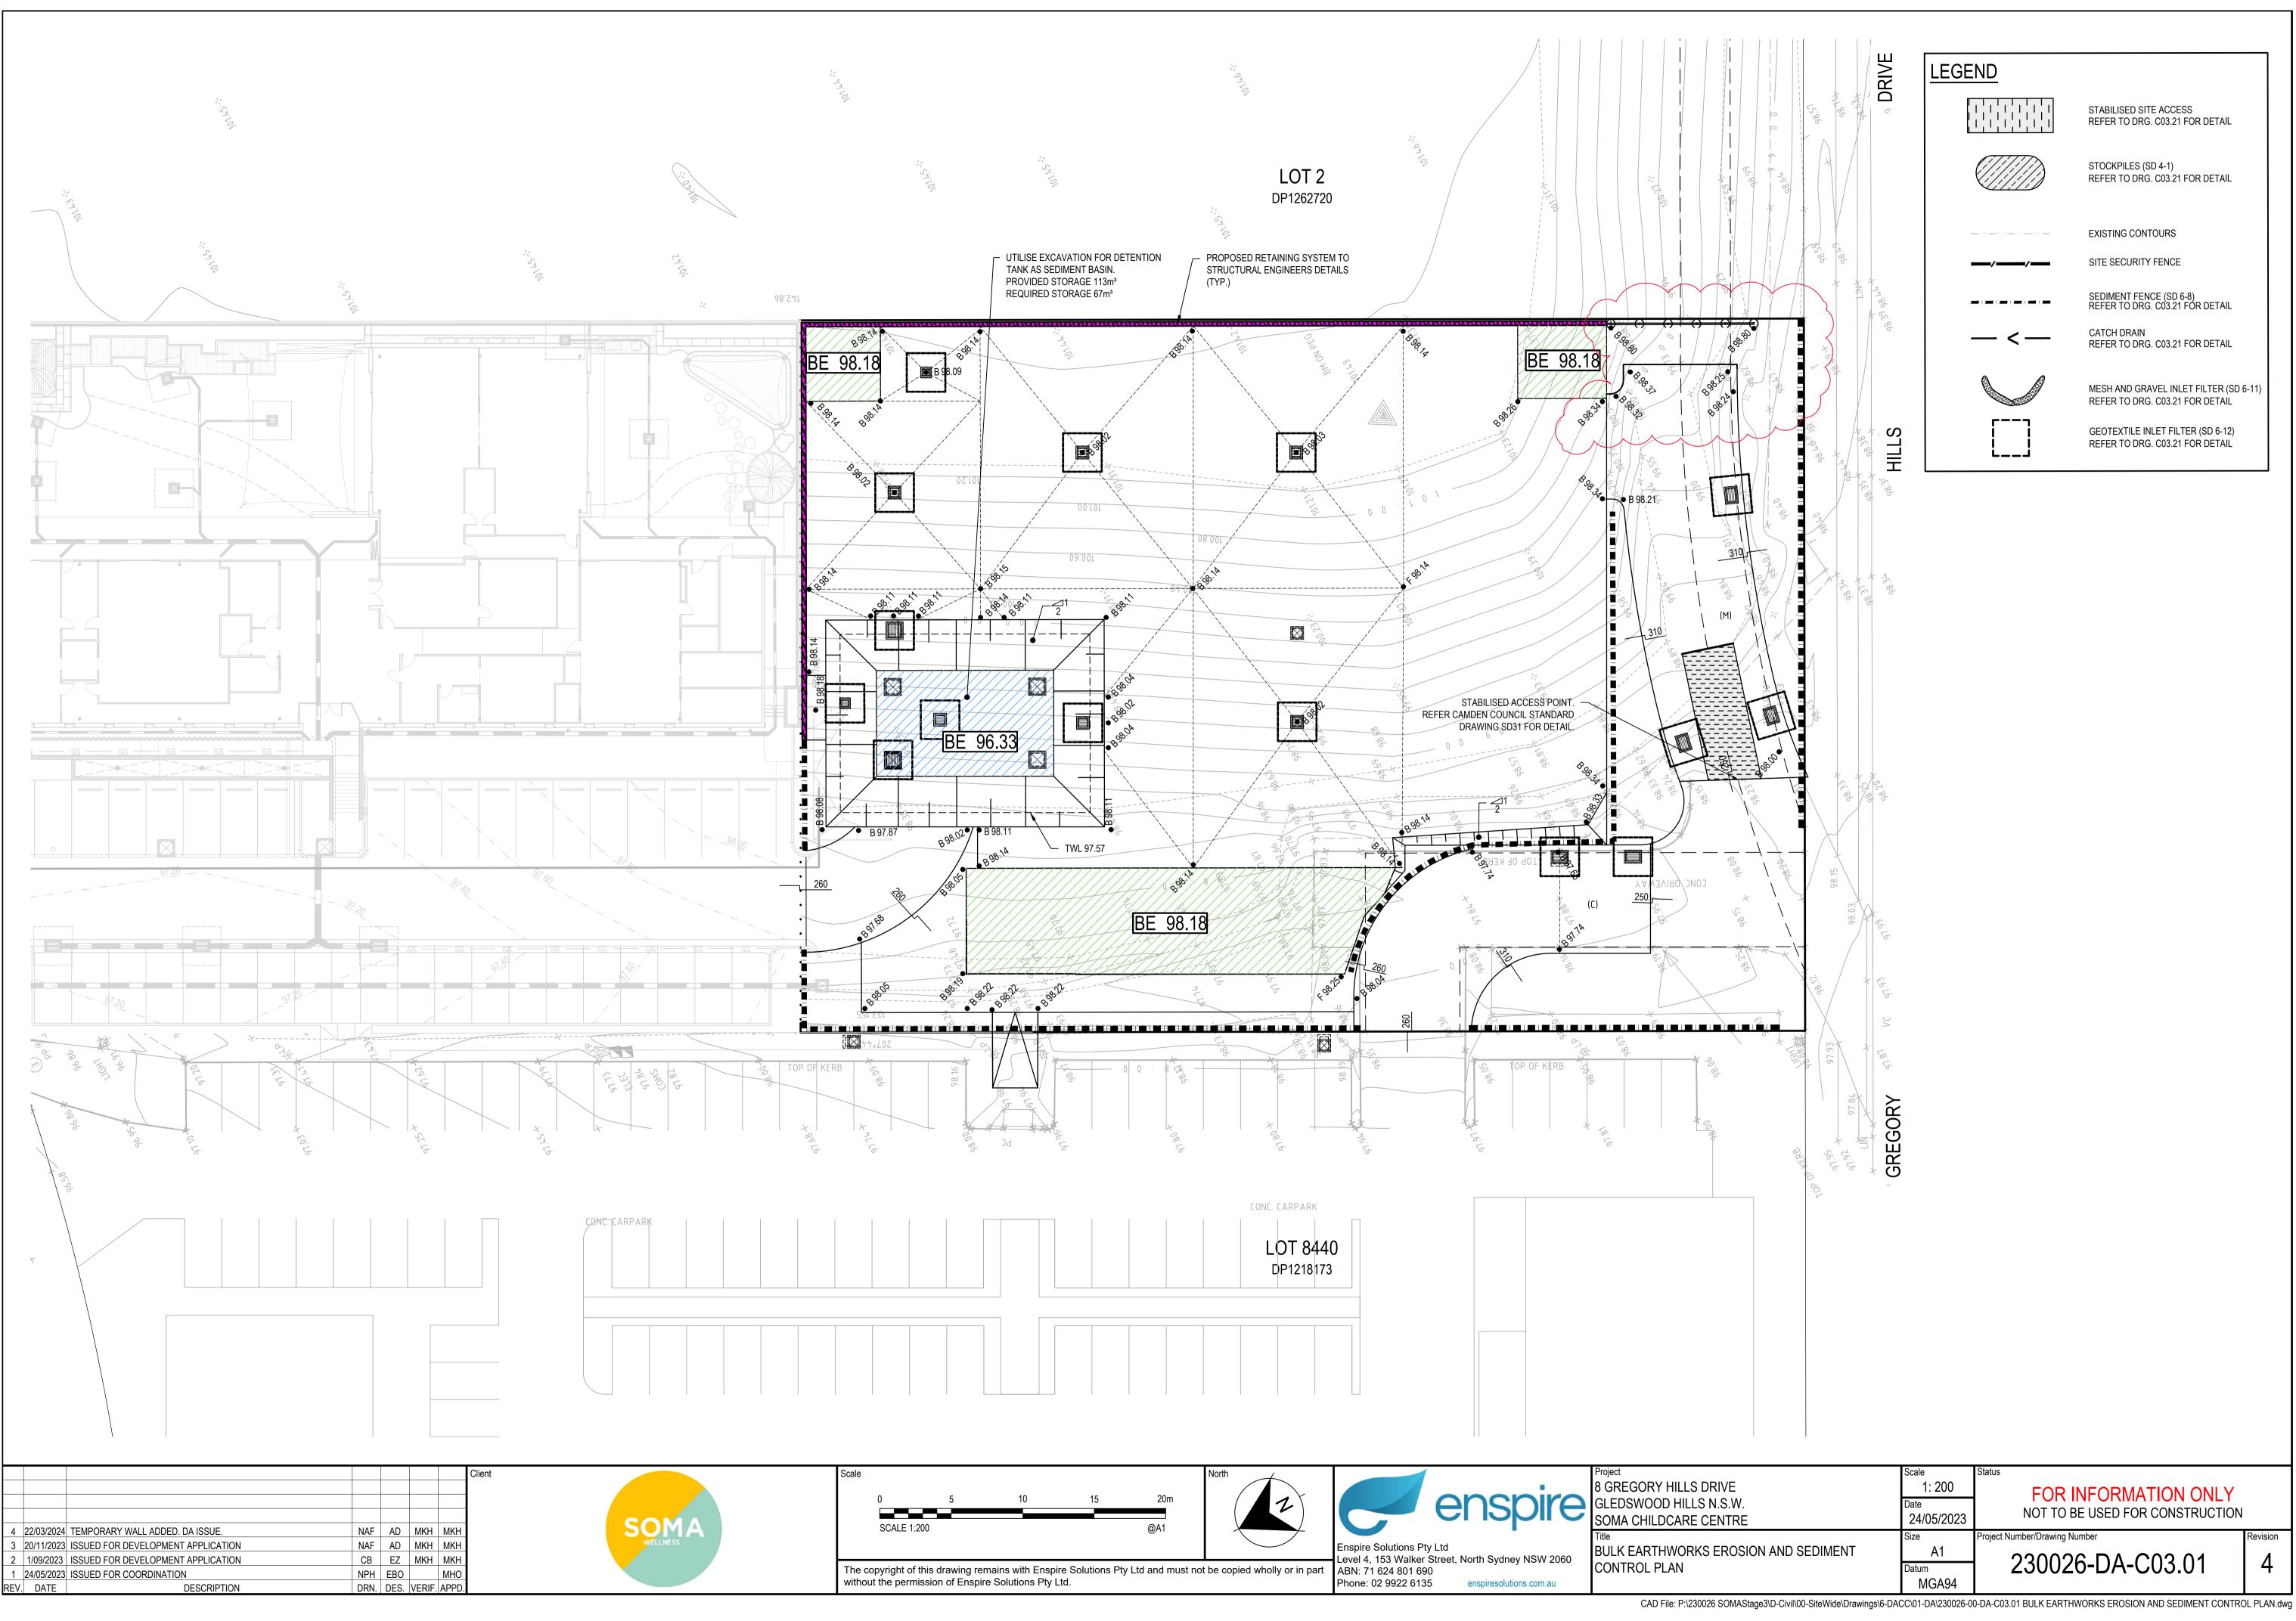
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-		MKH MKH MKH MKH			Enspire Solutions Pty Ltd Level 4, 153 Walker Street, North Sydney NSW 2060	EROSION AND SEDIMENT CONTROL DETAILS	A1	230026-DA-C03.21	2
1 RE\	24/05/2023 ISSUED FOR COORDINATION NPH EBO	MHC VERIF. APPI		The copyright of this drawing remains with Enspire Solutions Pty Ltd and must not be copied wholly or in pa without the permission of Enspire Solutions Pty Ltd.	t ABN: 71 624 801 690 Phone: 02 9922 6135 enspiresolutions.com.au		Datum MGA94	230020-DA-003.21	5

1. Erosion Haza Site Site Lo

Precinct

Other

Site area

Total catchment area (ha) Disturbed catchment area (ha)

Soil analysis (enter se

Soli analysis (e	enter se
Sediment Type (C, F	or D) if knov
% sand (fr	action 0.02
% silt (fra	ction 0.002
% clay (fraction	on finer than
	Dispersion
% (of whole soi

Soil Texture Group

Rainfall data

Design rainfall depth (no of days) Design rainfall depth (percentile) x-day, y-percentile rainfall event (Rainfall R-factor (if known) IFD: 2-year, 6-hour storm (if know

RUSLE Factors

Rainfall erosivity (<i>R</i> -factor)
Soil erodibility (K-factor)
Slope length (m)
Slope gradient (%)
Length/gradient (LS -factor)
Erosion control practice (P -factor
Ground cover (C-factor)

Sediment Basin Desig Storage (soil) zone design (no of r


Cv (Volumetric runoff coefficient)


Calculations and Type

Soil loss (t/ha/yr) Soil Loss Class Soil loss (m°/ha/yr) Sediment basin storage (soil) volu Sediment basin settling (water) vo Sediment basin total volume (m³


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diment t	ype if k	nown	, or lat	orator	y parti	cle siz	e data)
vn:	D				-		From Appendix C (if known)
o 2.00 mm)	29						Enter the percentage of each soil
o 0.02 mm)	29						Enter the percentage of each soil fraction. E.g. enter 10 for 10%
0.002 mm)	29						пасион. с.у. спист 10 юг 1070
percentage							E.g. enter 10 for dispersion of 10%
dispersible							See Section 6.3.3(e). Auto-calculated
	D						Automatic calculation from above
	5						See Section 6.3.4 and, particularly,
	75						Table 6.3 on pages 6-24 and 6-25.
mm)	20.2						
(1)	9.5						Only need to enter one or the other here
'n)	9.5						
	2020						Auto-filled from above
	0.075						
	65						
	5.6						RUSLE LS factor calculated for a high
	1.20						rill/interrill ratio.
	1.3	1.3	1.3	1.3	1.3	1.3	1
	1	1	1	1	1	1	
n Criteria	a (for T	ype D	/F basi	ns only	/. Leav	e blan	nk for Type C basins)
non <mark>th</mark> s)	2						Minimum is generally 2 months
	0.79						See Table F2, page F-4 in Appendix F
D/F Sec	liment	Basin	Volum	es			
	236						
	3						See Table 4.2, page 4-13
	182						Conversion to cubic metres
me (m ³)	11						See Sections 6.3.4(i) for calculations
lume (m ³)	56						See Sections 6.3.4(i) for calculations
	67		I			I	

NB for sizing of Type C (coarse) sediment basins, see Worksheet 3 (if required).

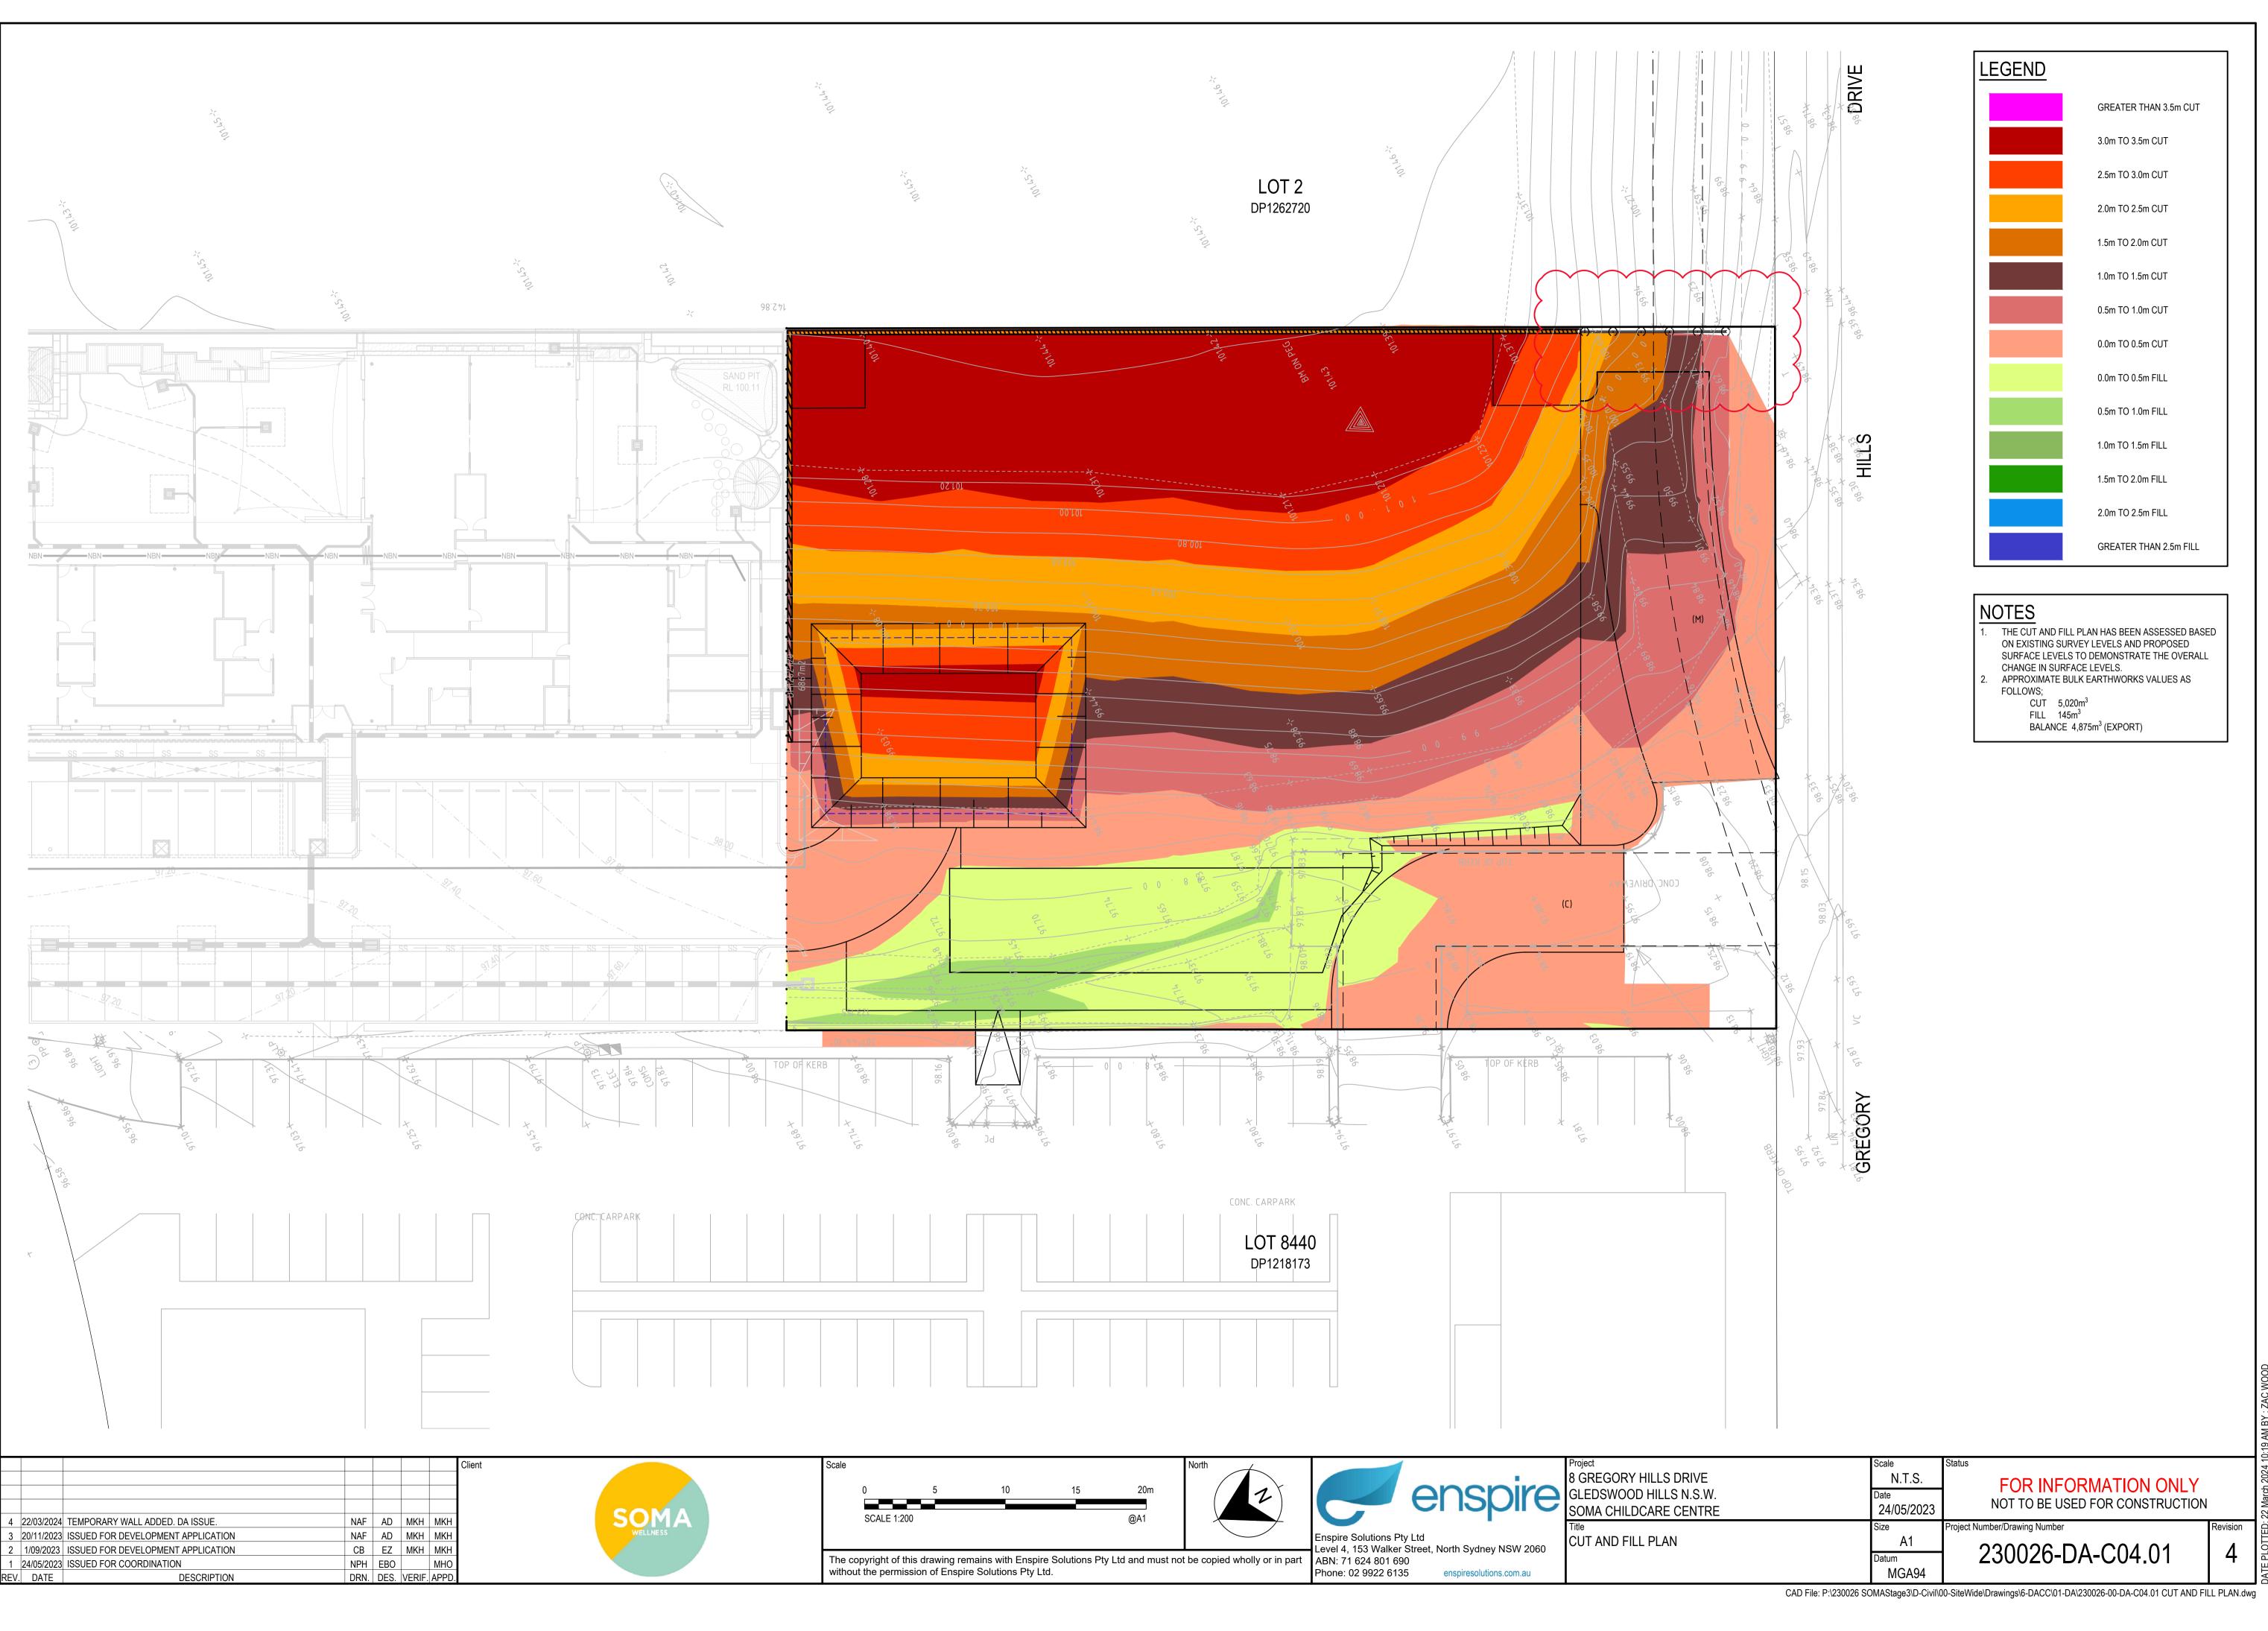

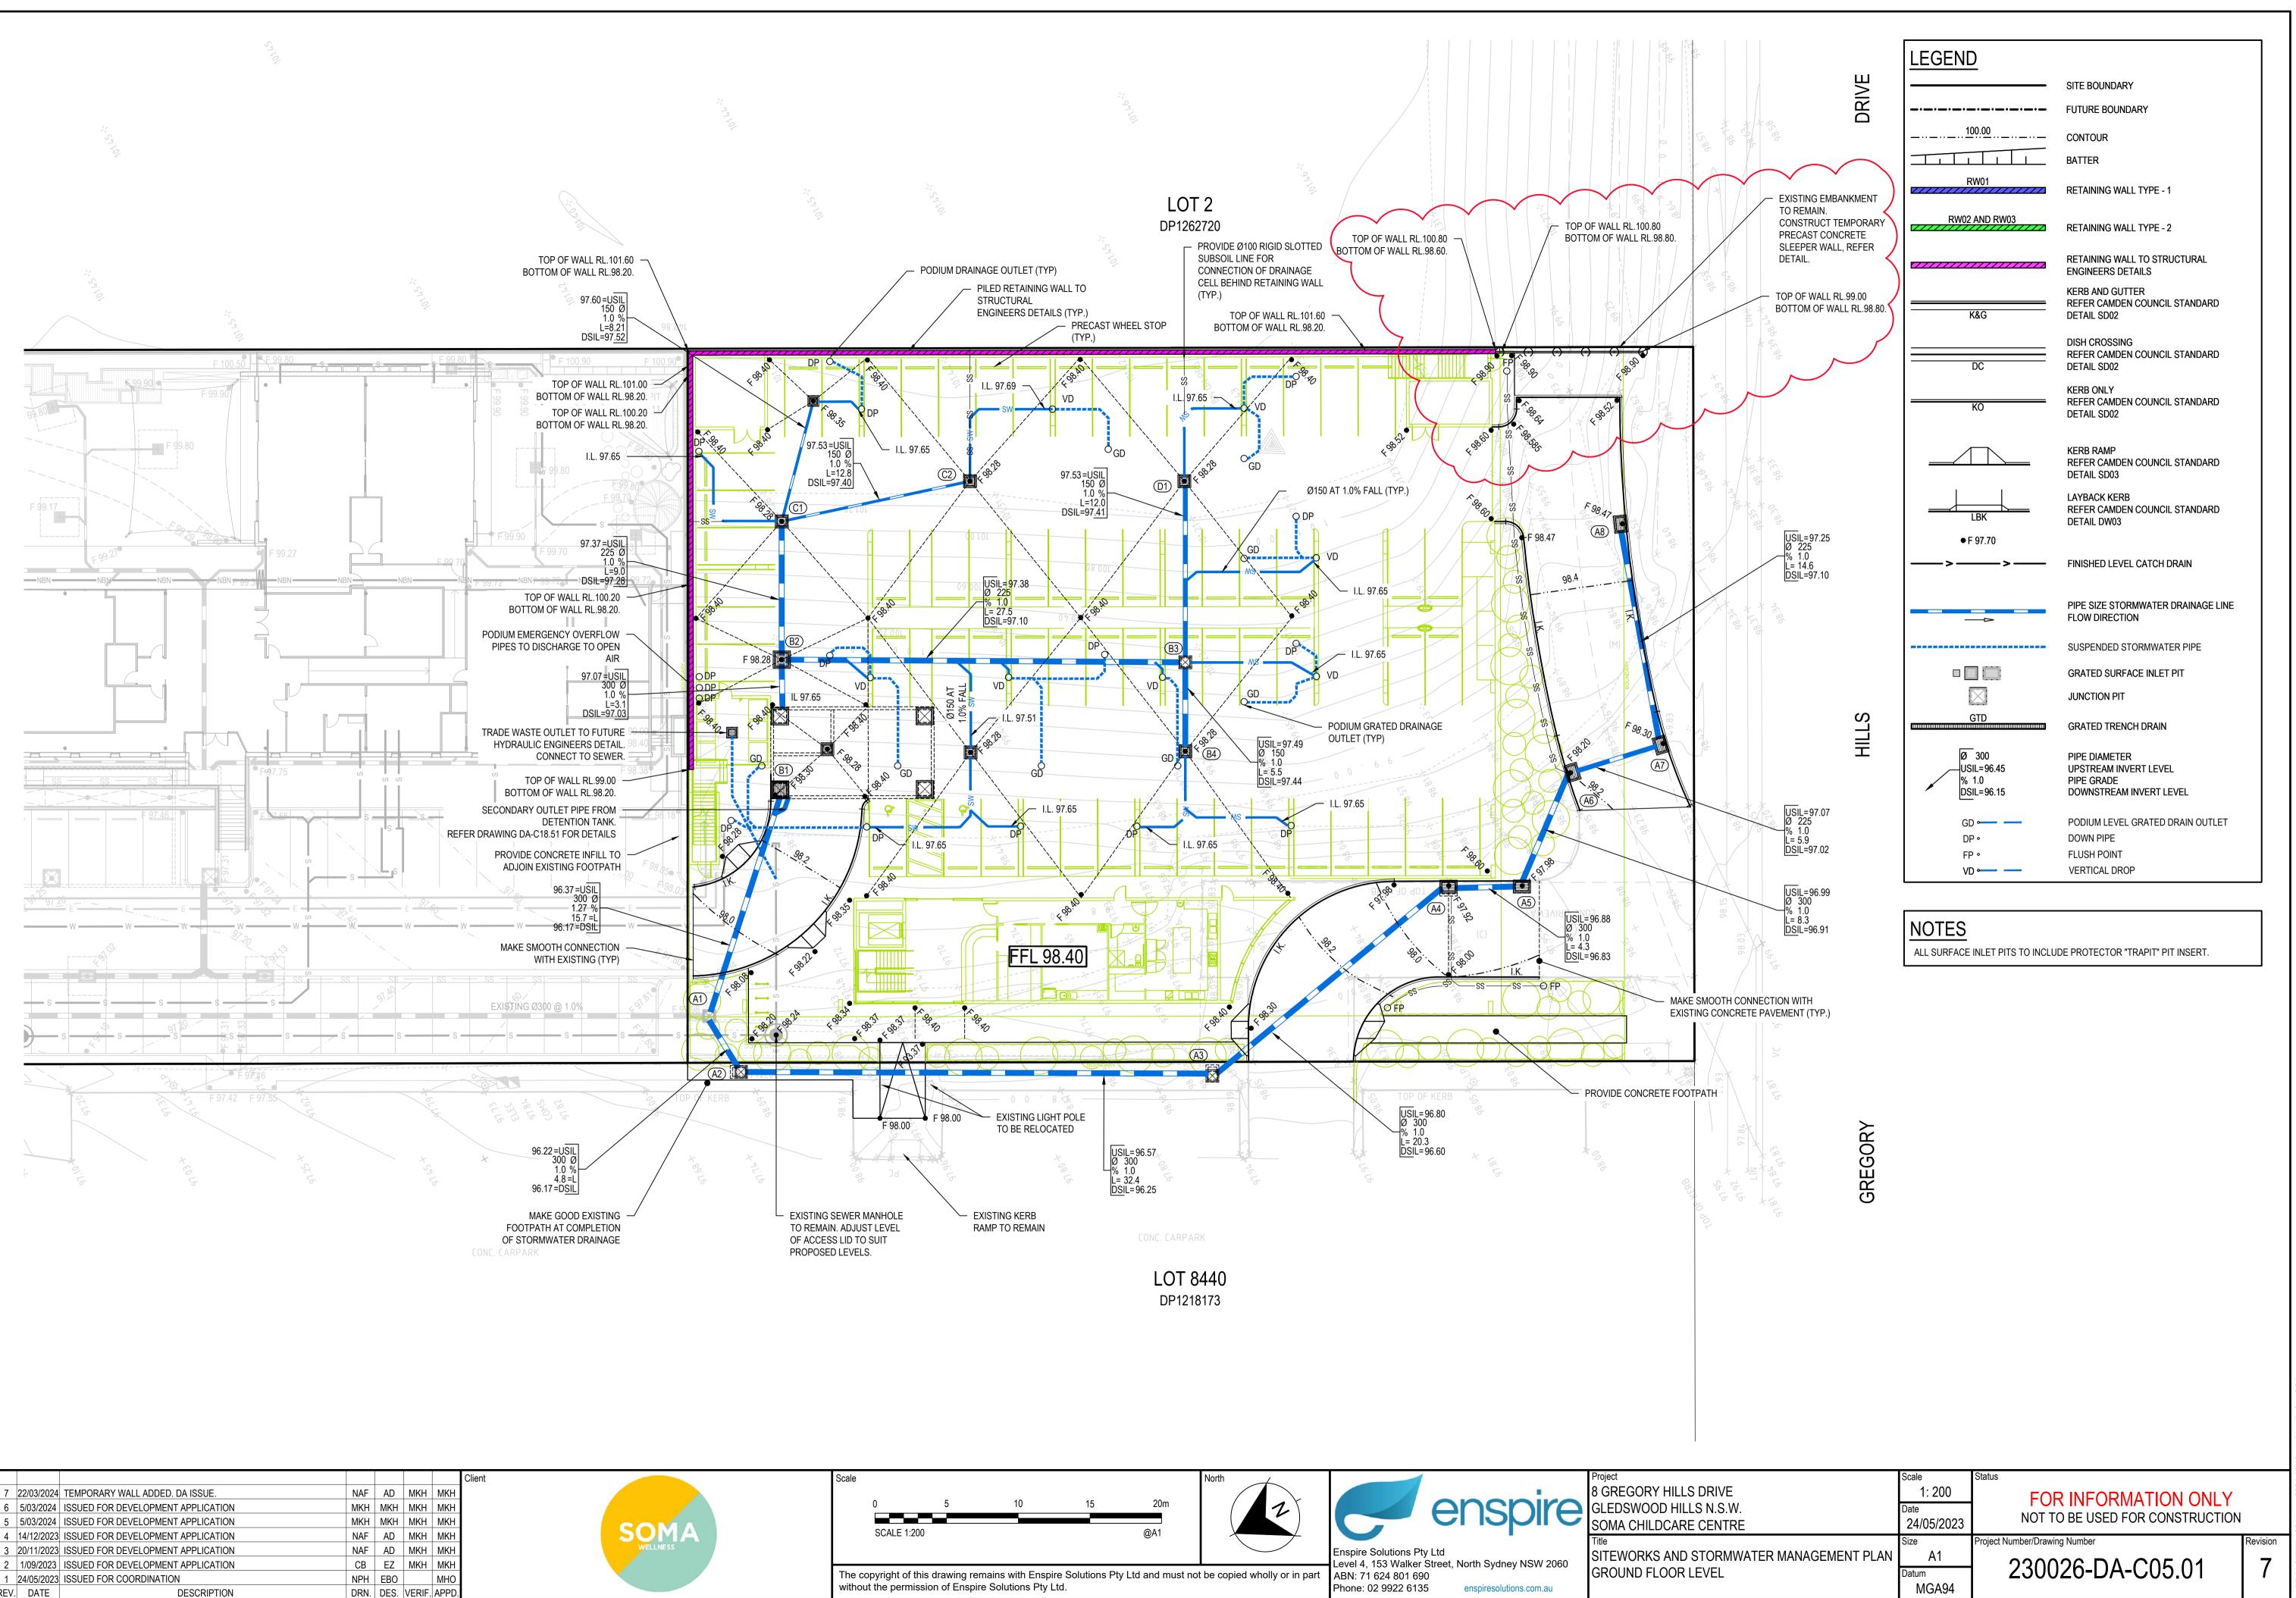


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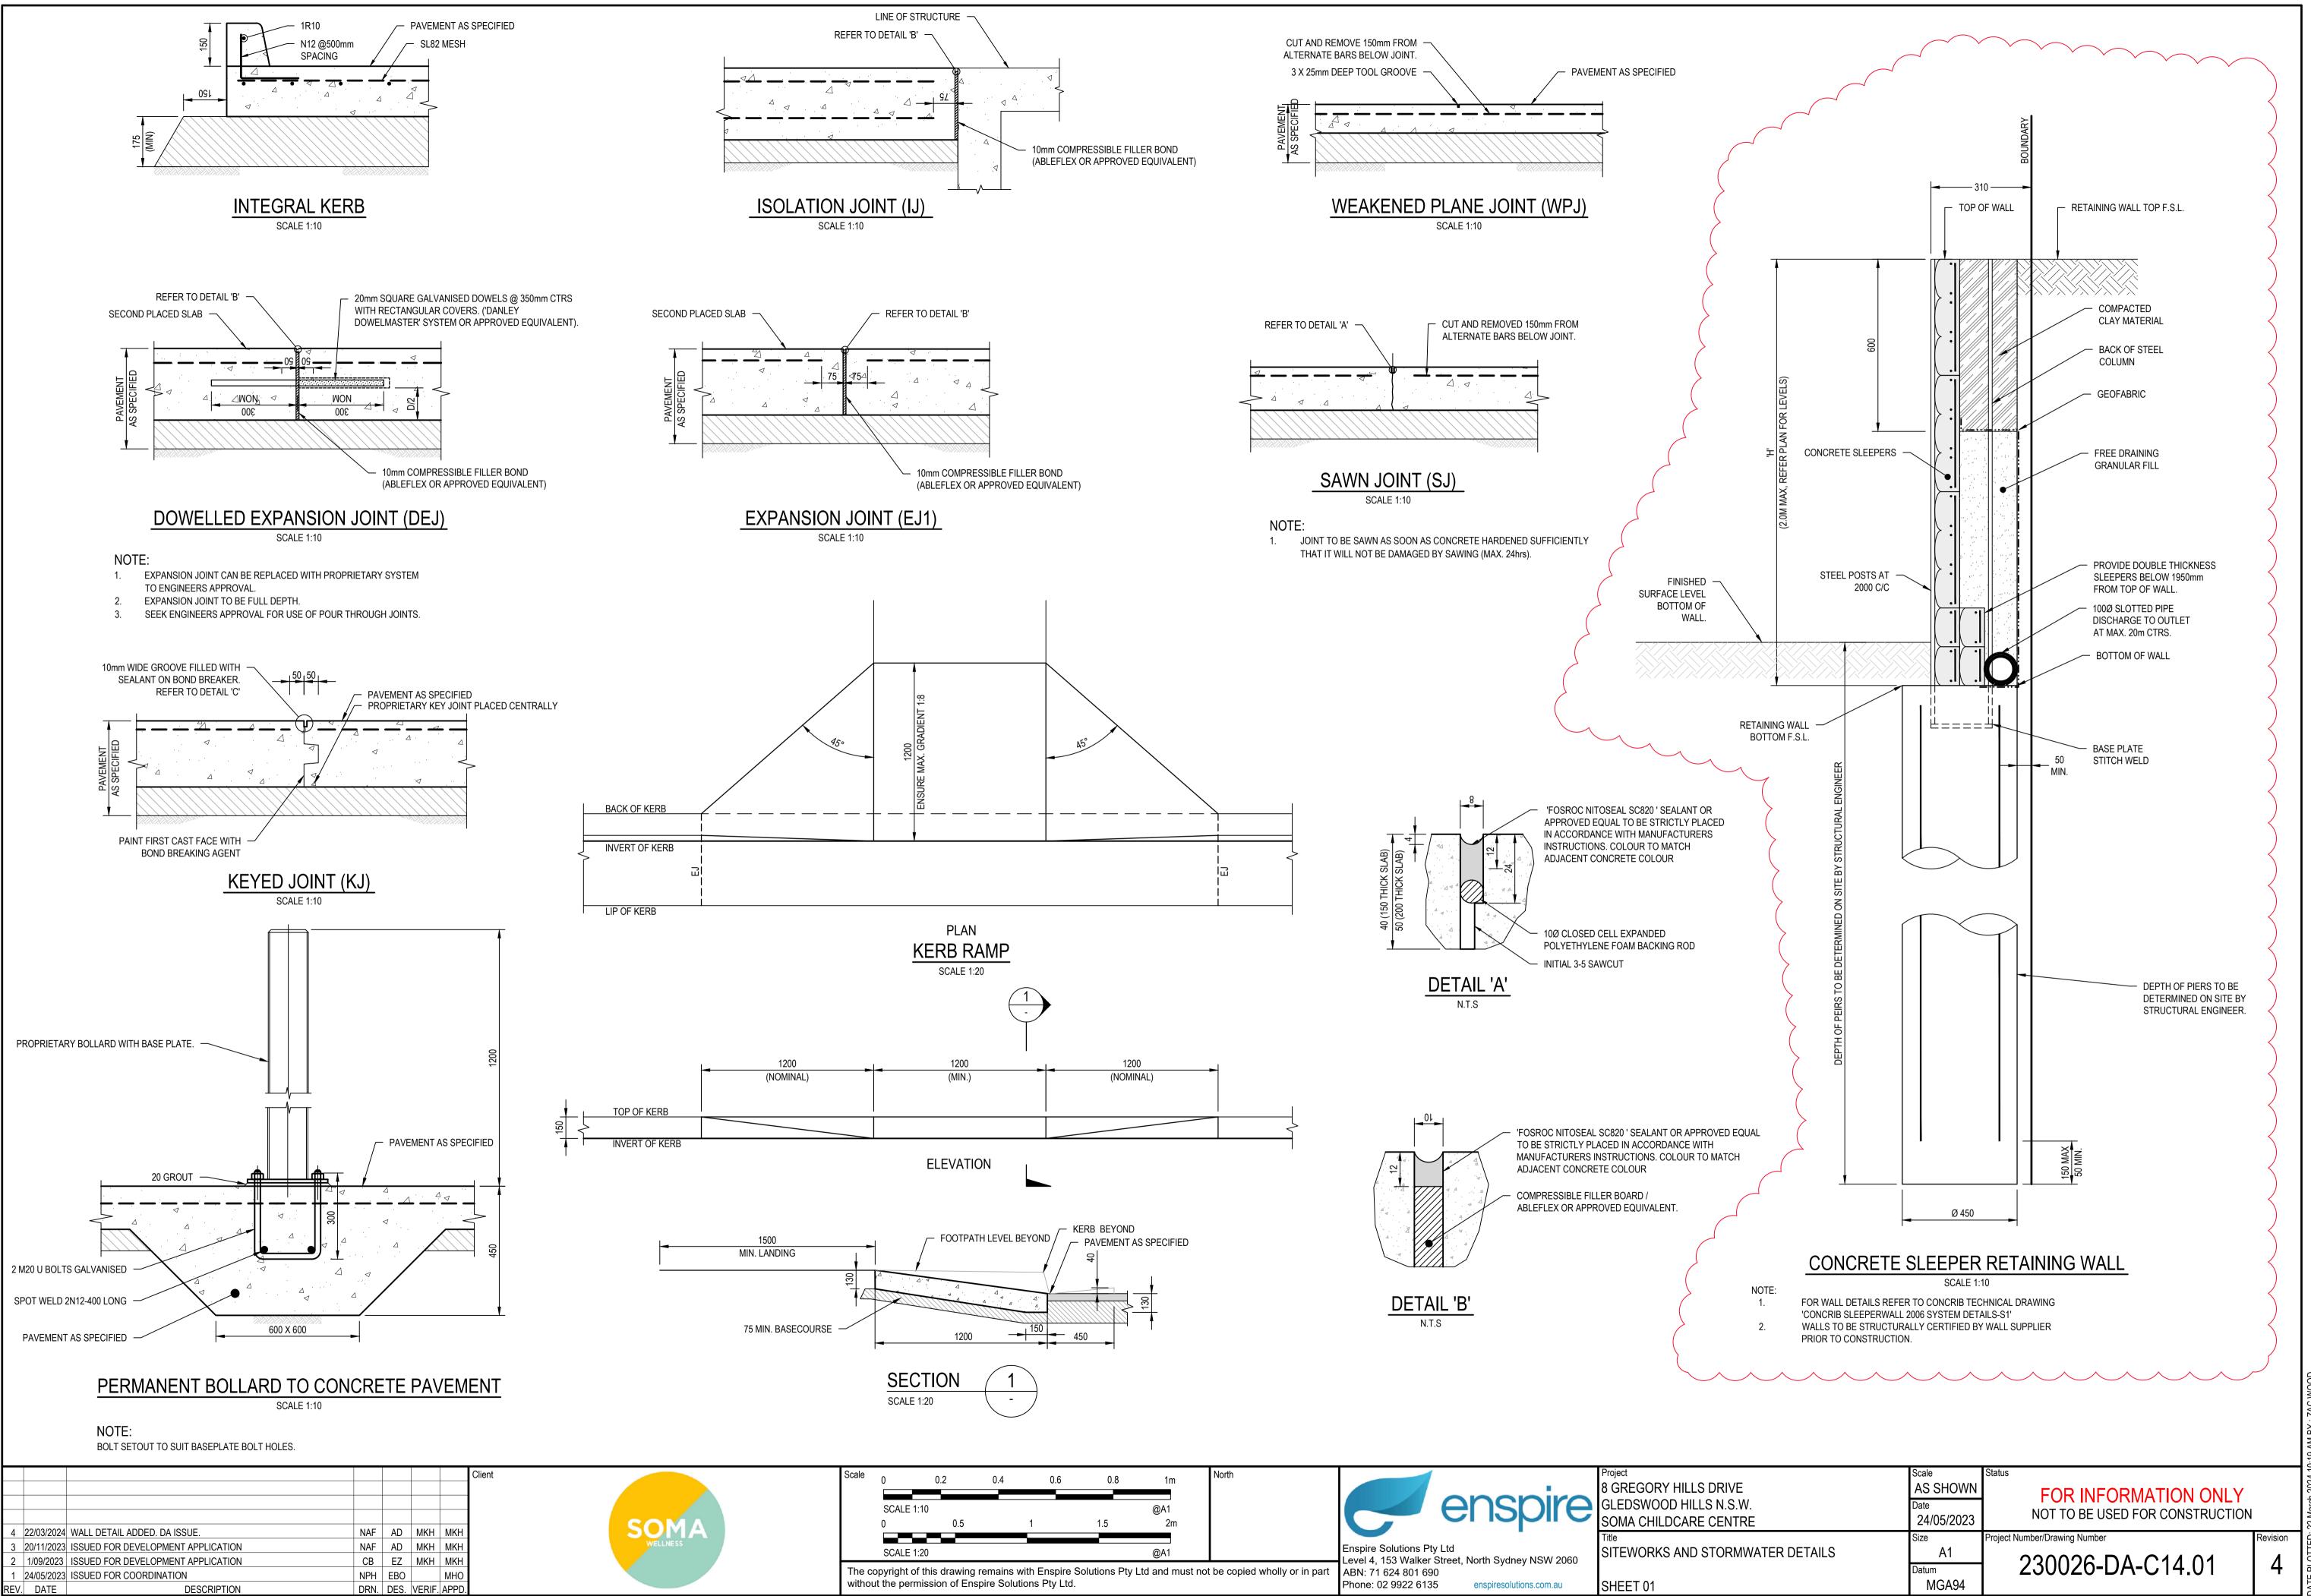
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				ving remains Enspire So			ns Pty Lte	d and must no	t be copied wholly or in part	Level 4, 153 Walker Street, North Sydney NSW 2060 ABN: 71 624 801 690 Phone: 02 9922 6135 enspiresolutions.com.au	PODIUM AND ROOF PLAN
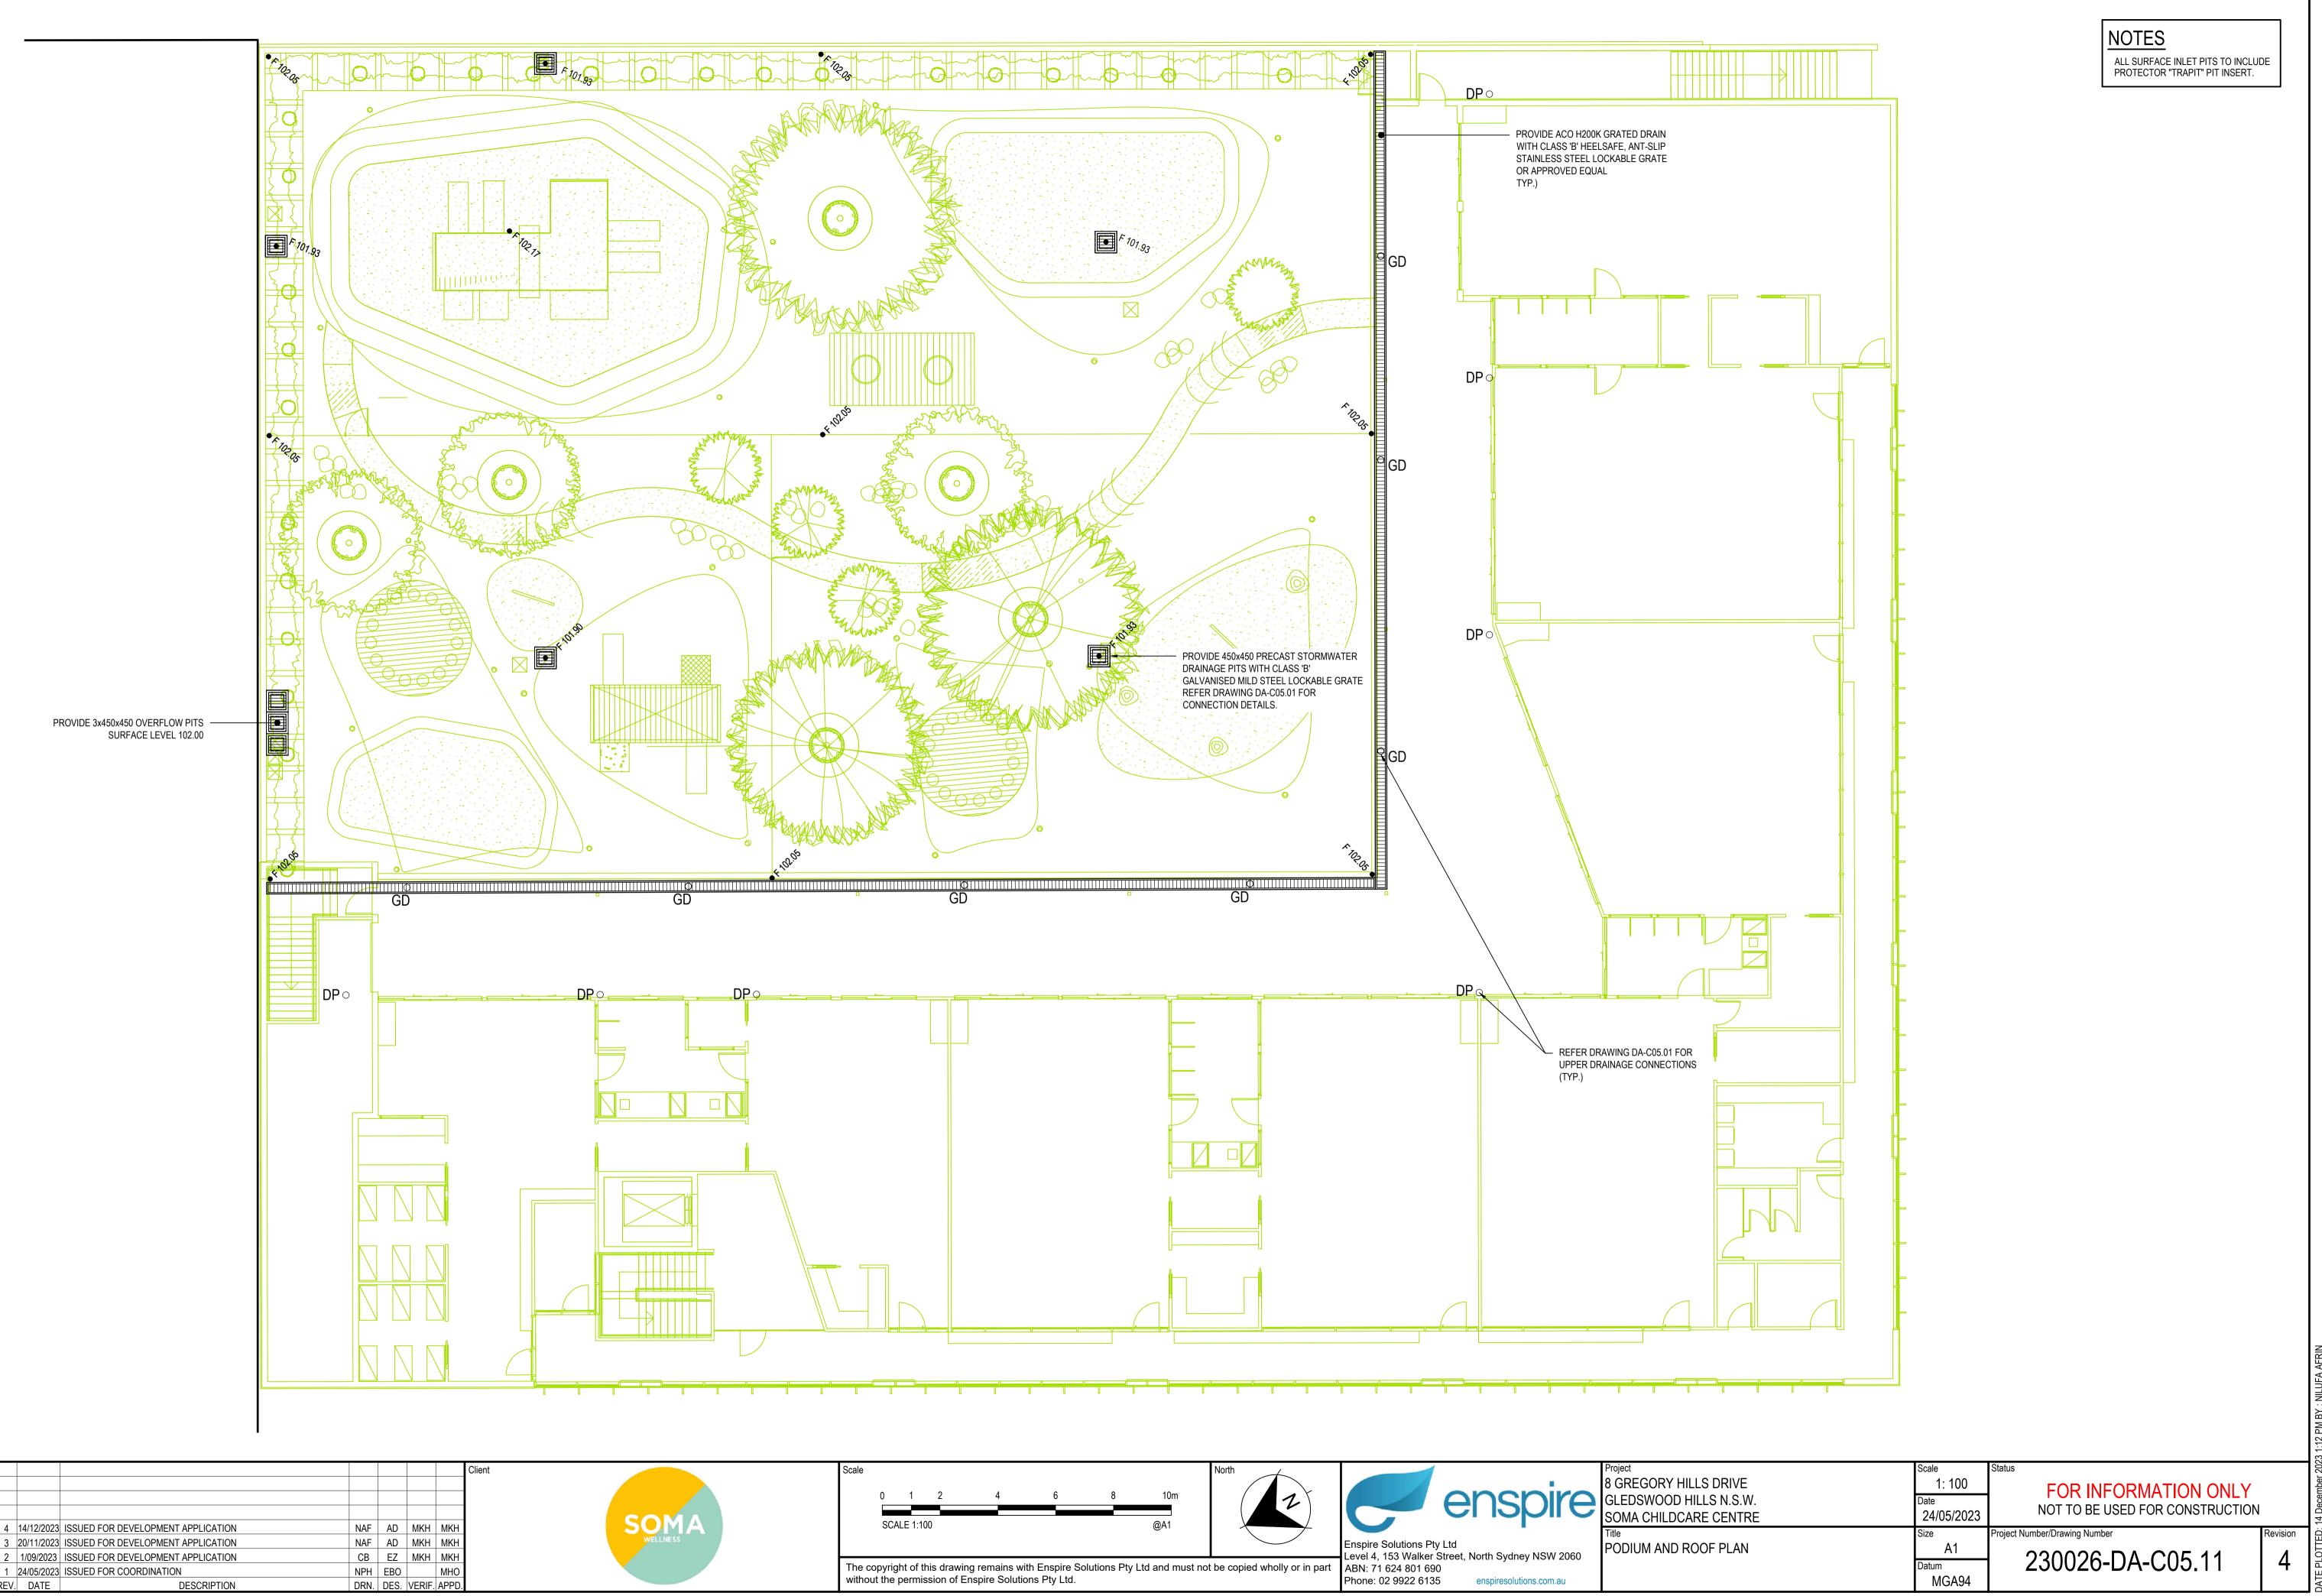
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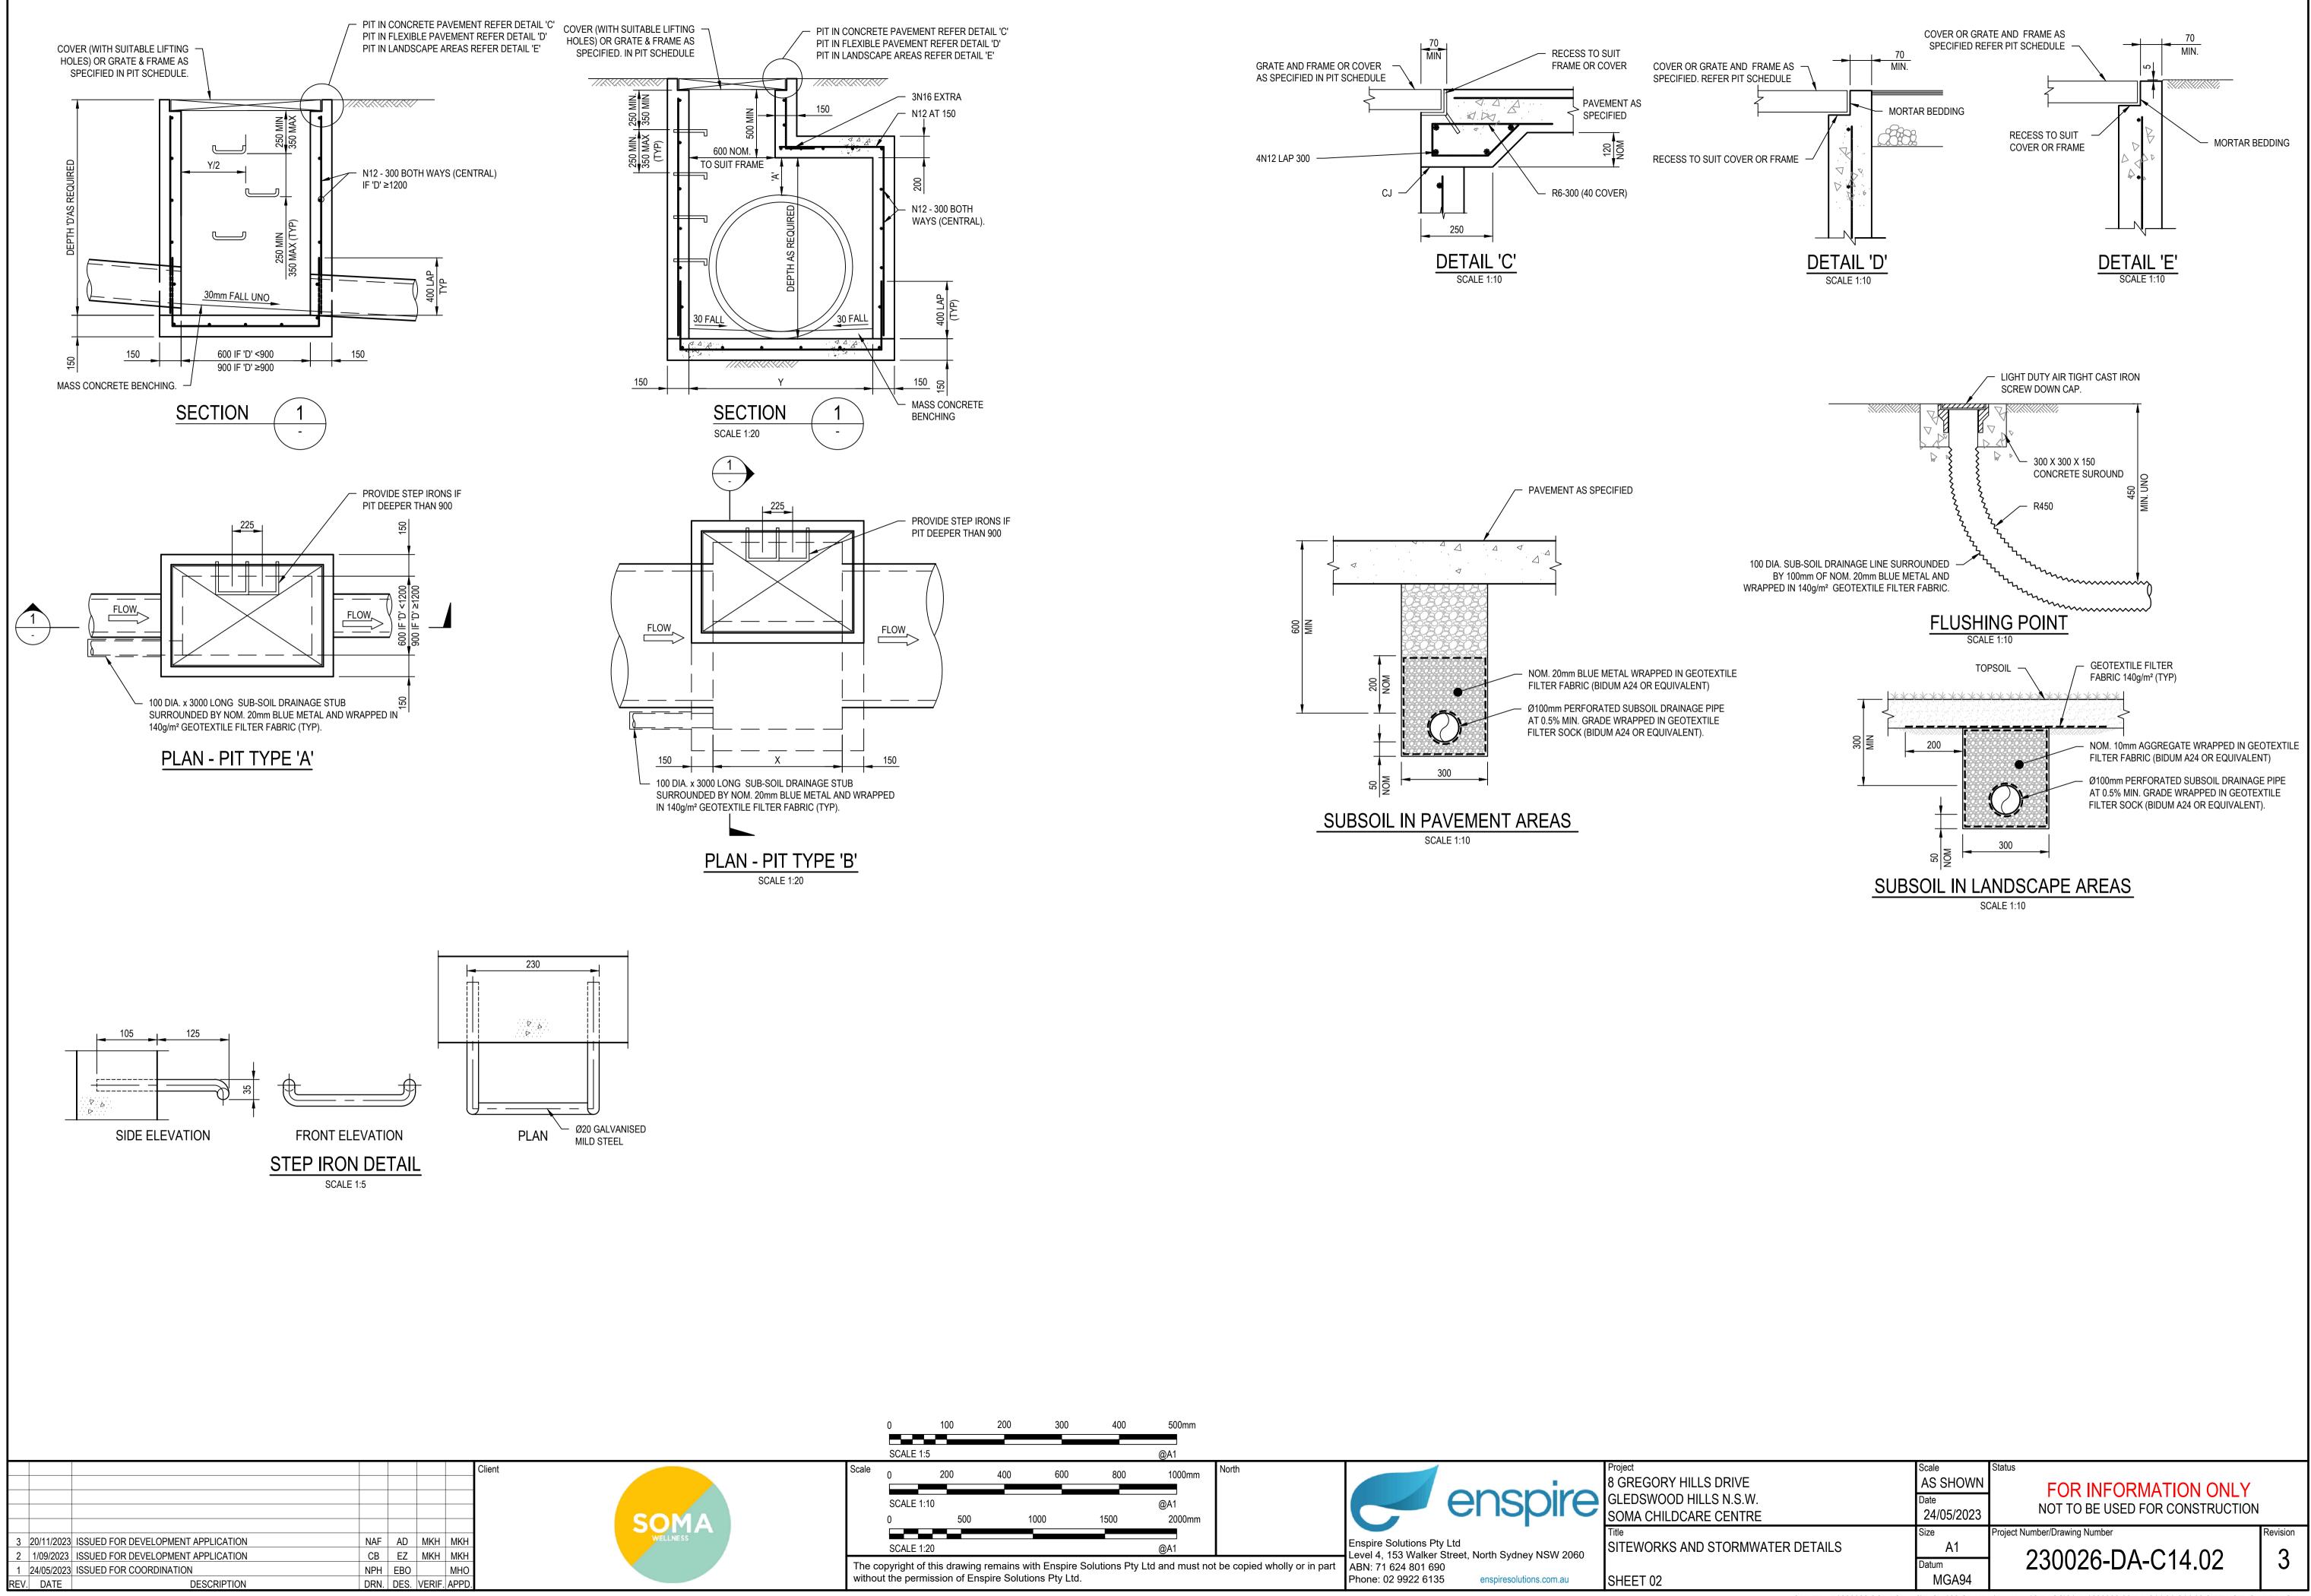
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CAD File: P:\230026 SOMAStage3\D-Civil\00-SiteWide\Drawings\6-DACC\01-DA\230026-00-DA-C11.01 PAVEMENT SIGNAGE AND LINEMARKING PLAN.dwg





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4	22/03/2024	WALL DETAIL ADDED. DA ISSUE.	NAF	AD	MKH	MKH	SOMA	
3	20/11/2023	ISSUED FOR DEVELOPMENT APPLICATION	NAF	AD	MKH	MKH	WELLNESS	
2	1/09/2023	ISSUED FOR DEVELOPMENT APPLICATION	СВ	ΕZ	MKH	MKH		
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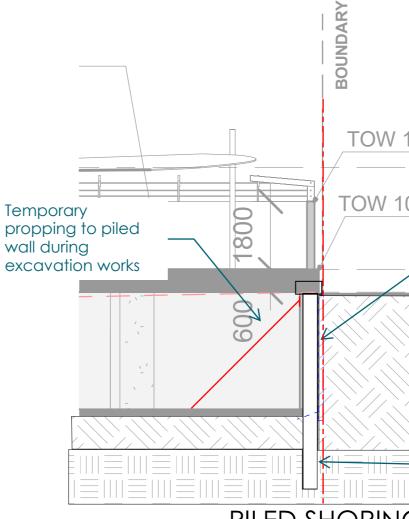
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PILED SHORING WALL

This option allows all work to be undertaken within our site.
 Soldier pile wall to be 150mm from boundary, 450mm DIA piles spacing TBC.

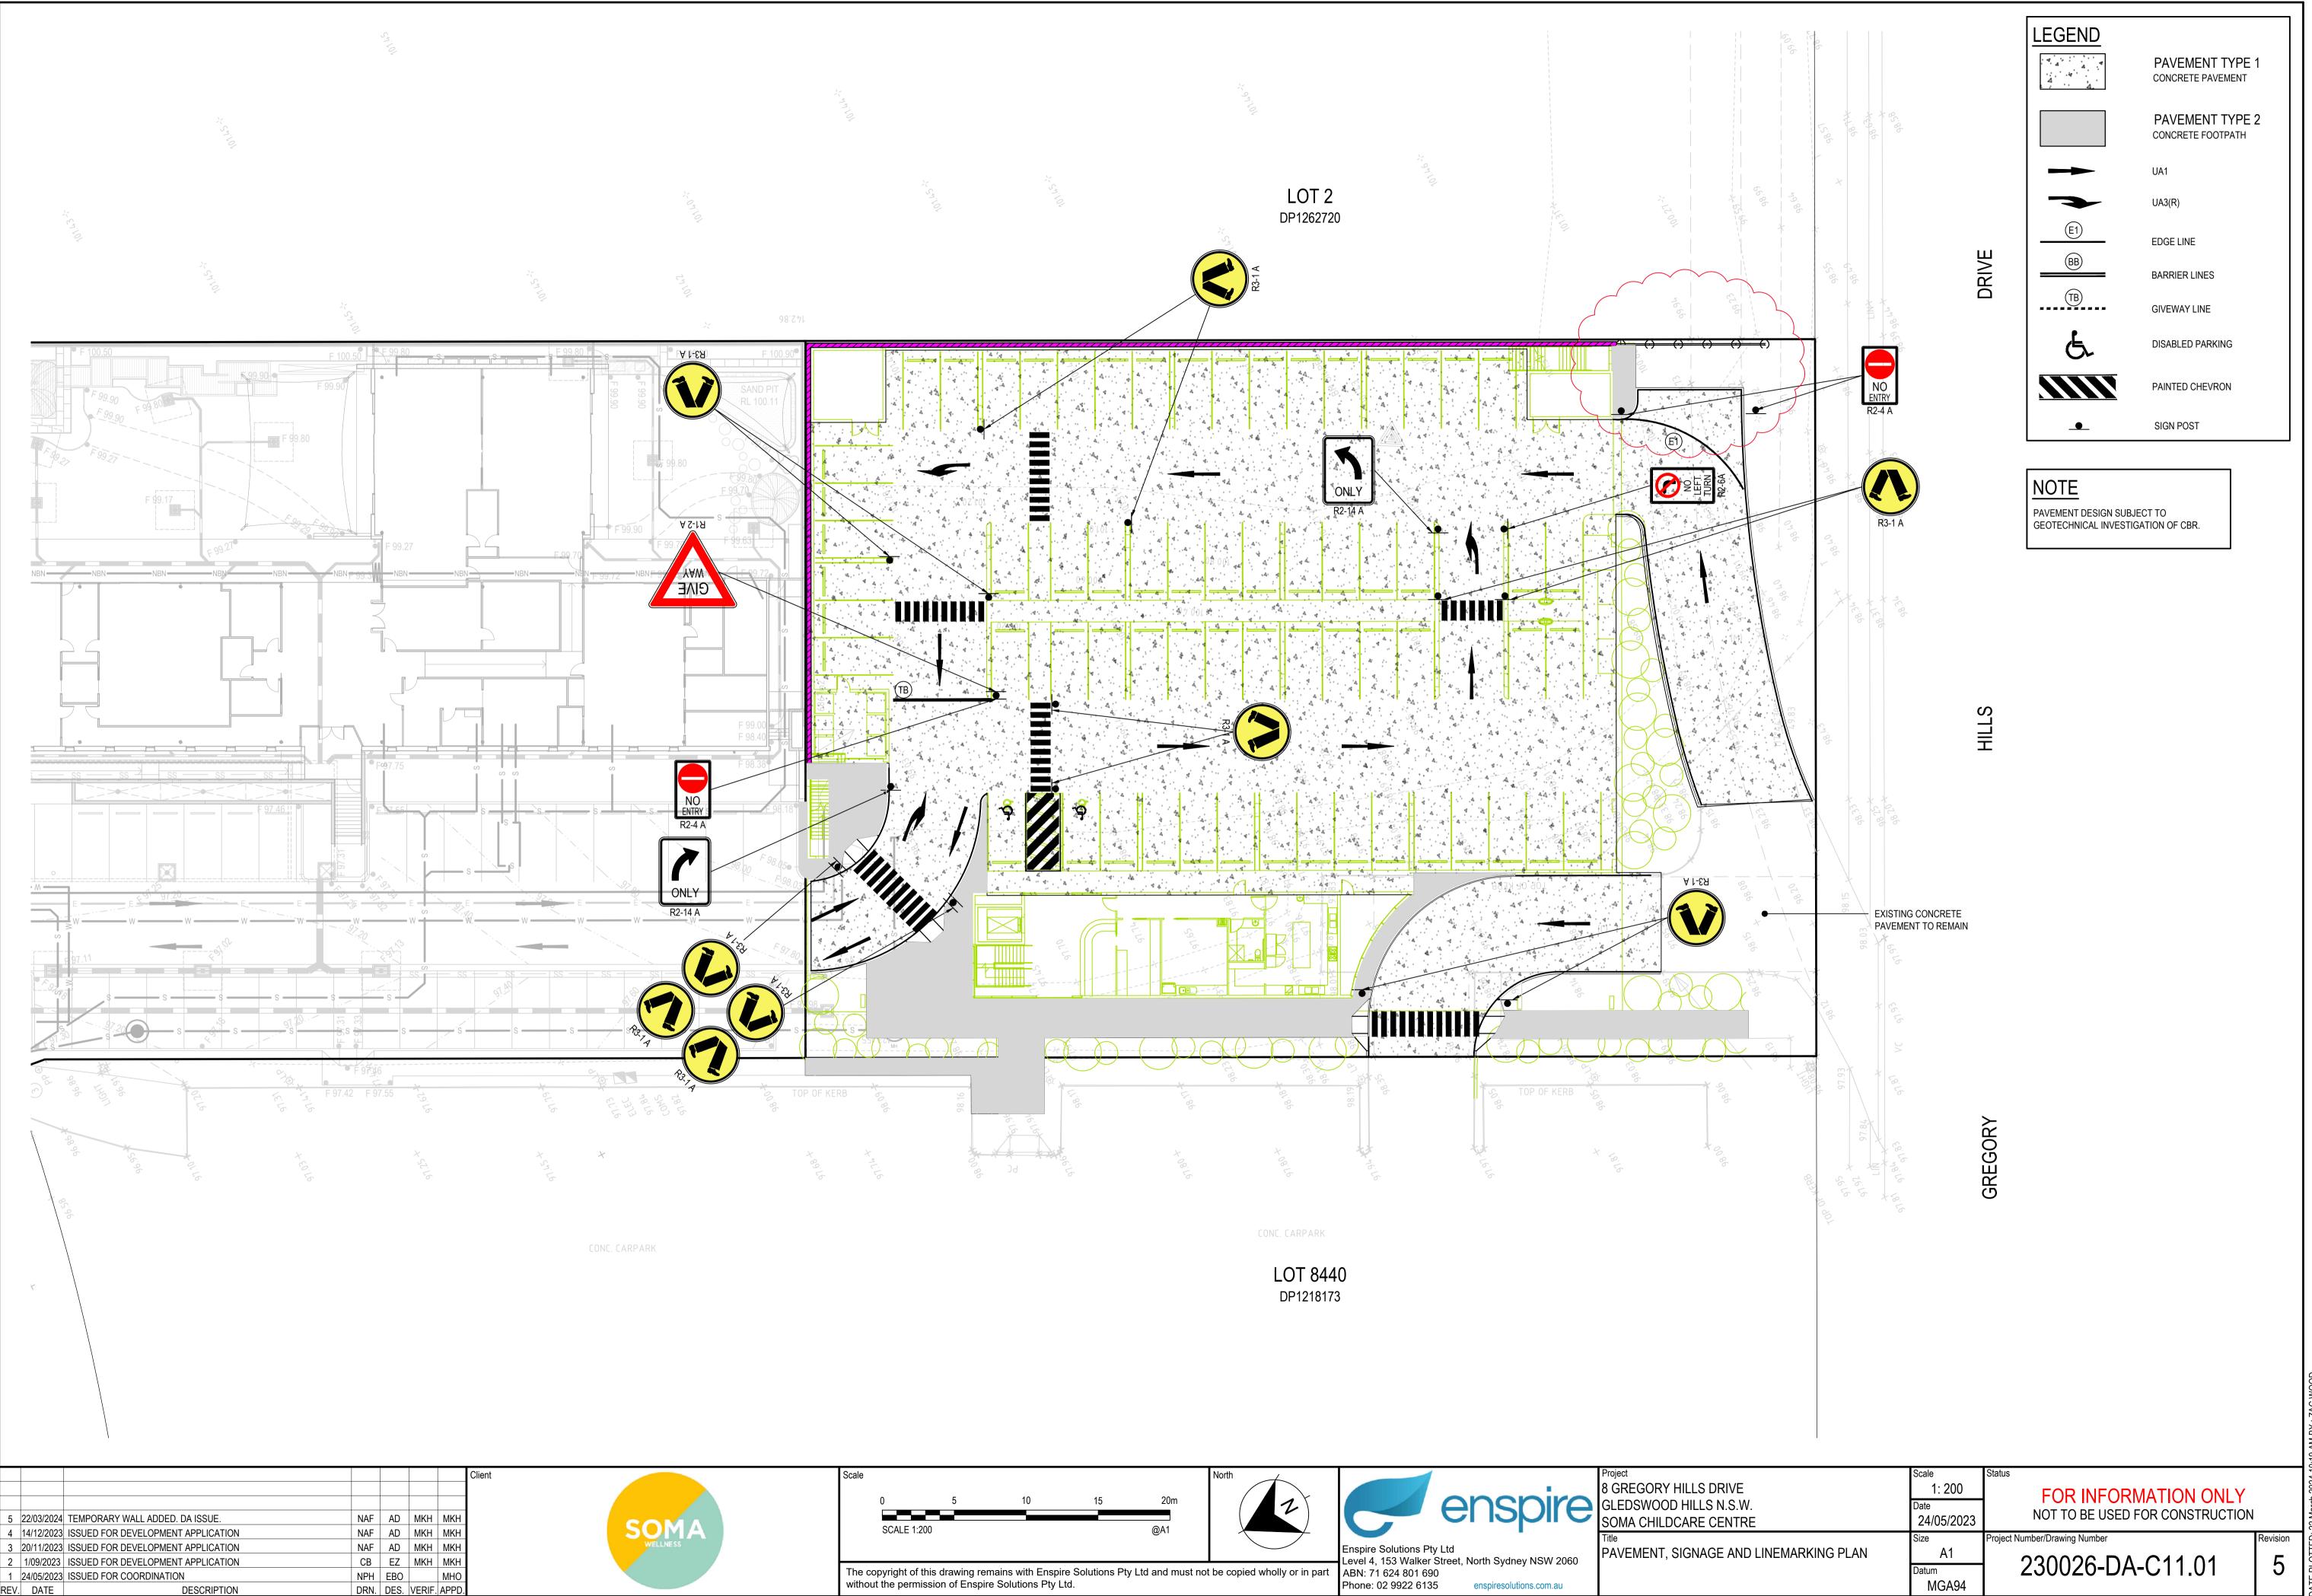3. Shotcrete wall spanning between piles, thickness TBC. Each shotcrete panel to have strip drain cell connected to sub soil drainage under slab.

4. Wall is designed as a "wet wall" construction.5. Shoring wall will need to be propped until the slab over is poured and cured, providing lateral restraint.

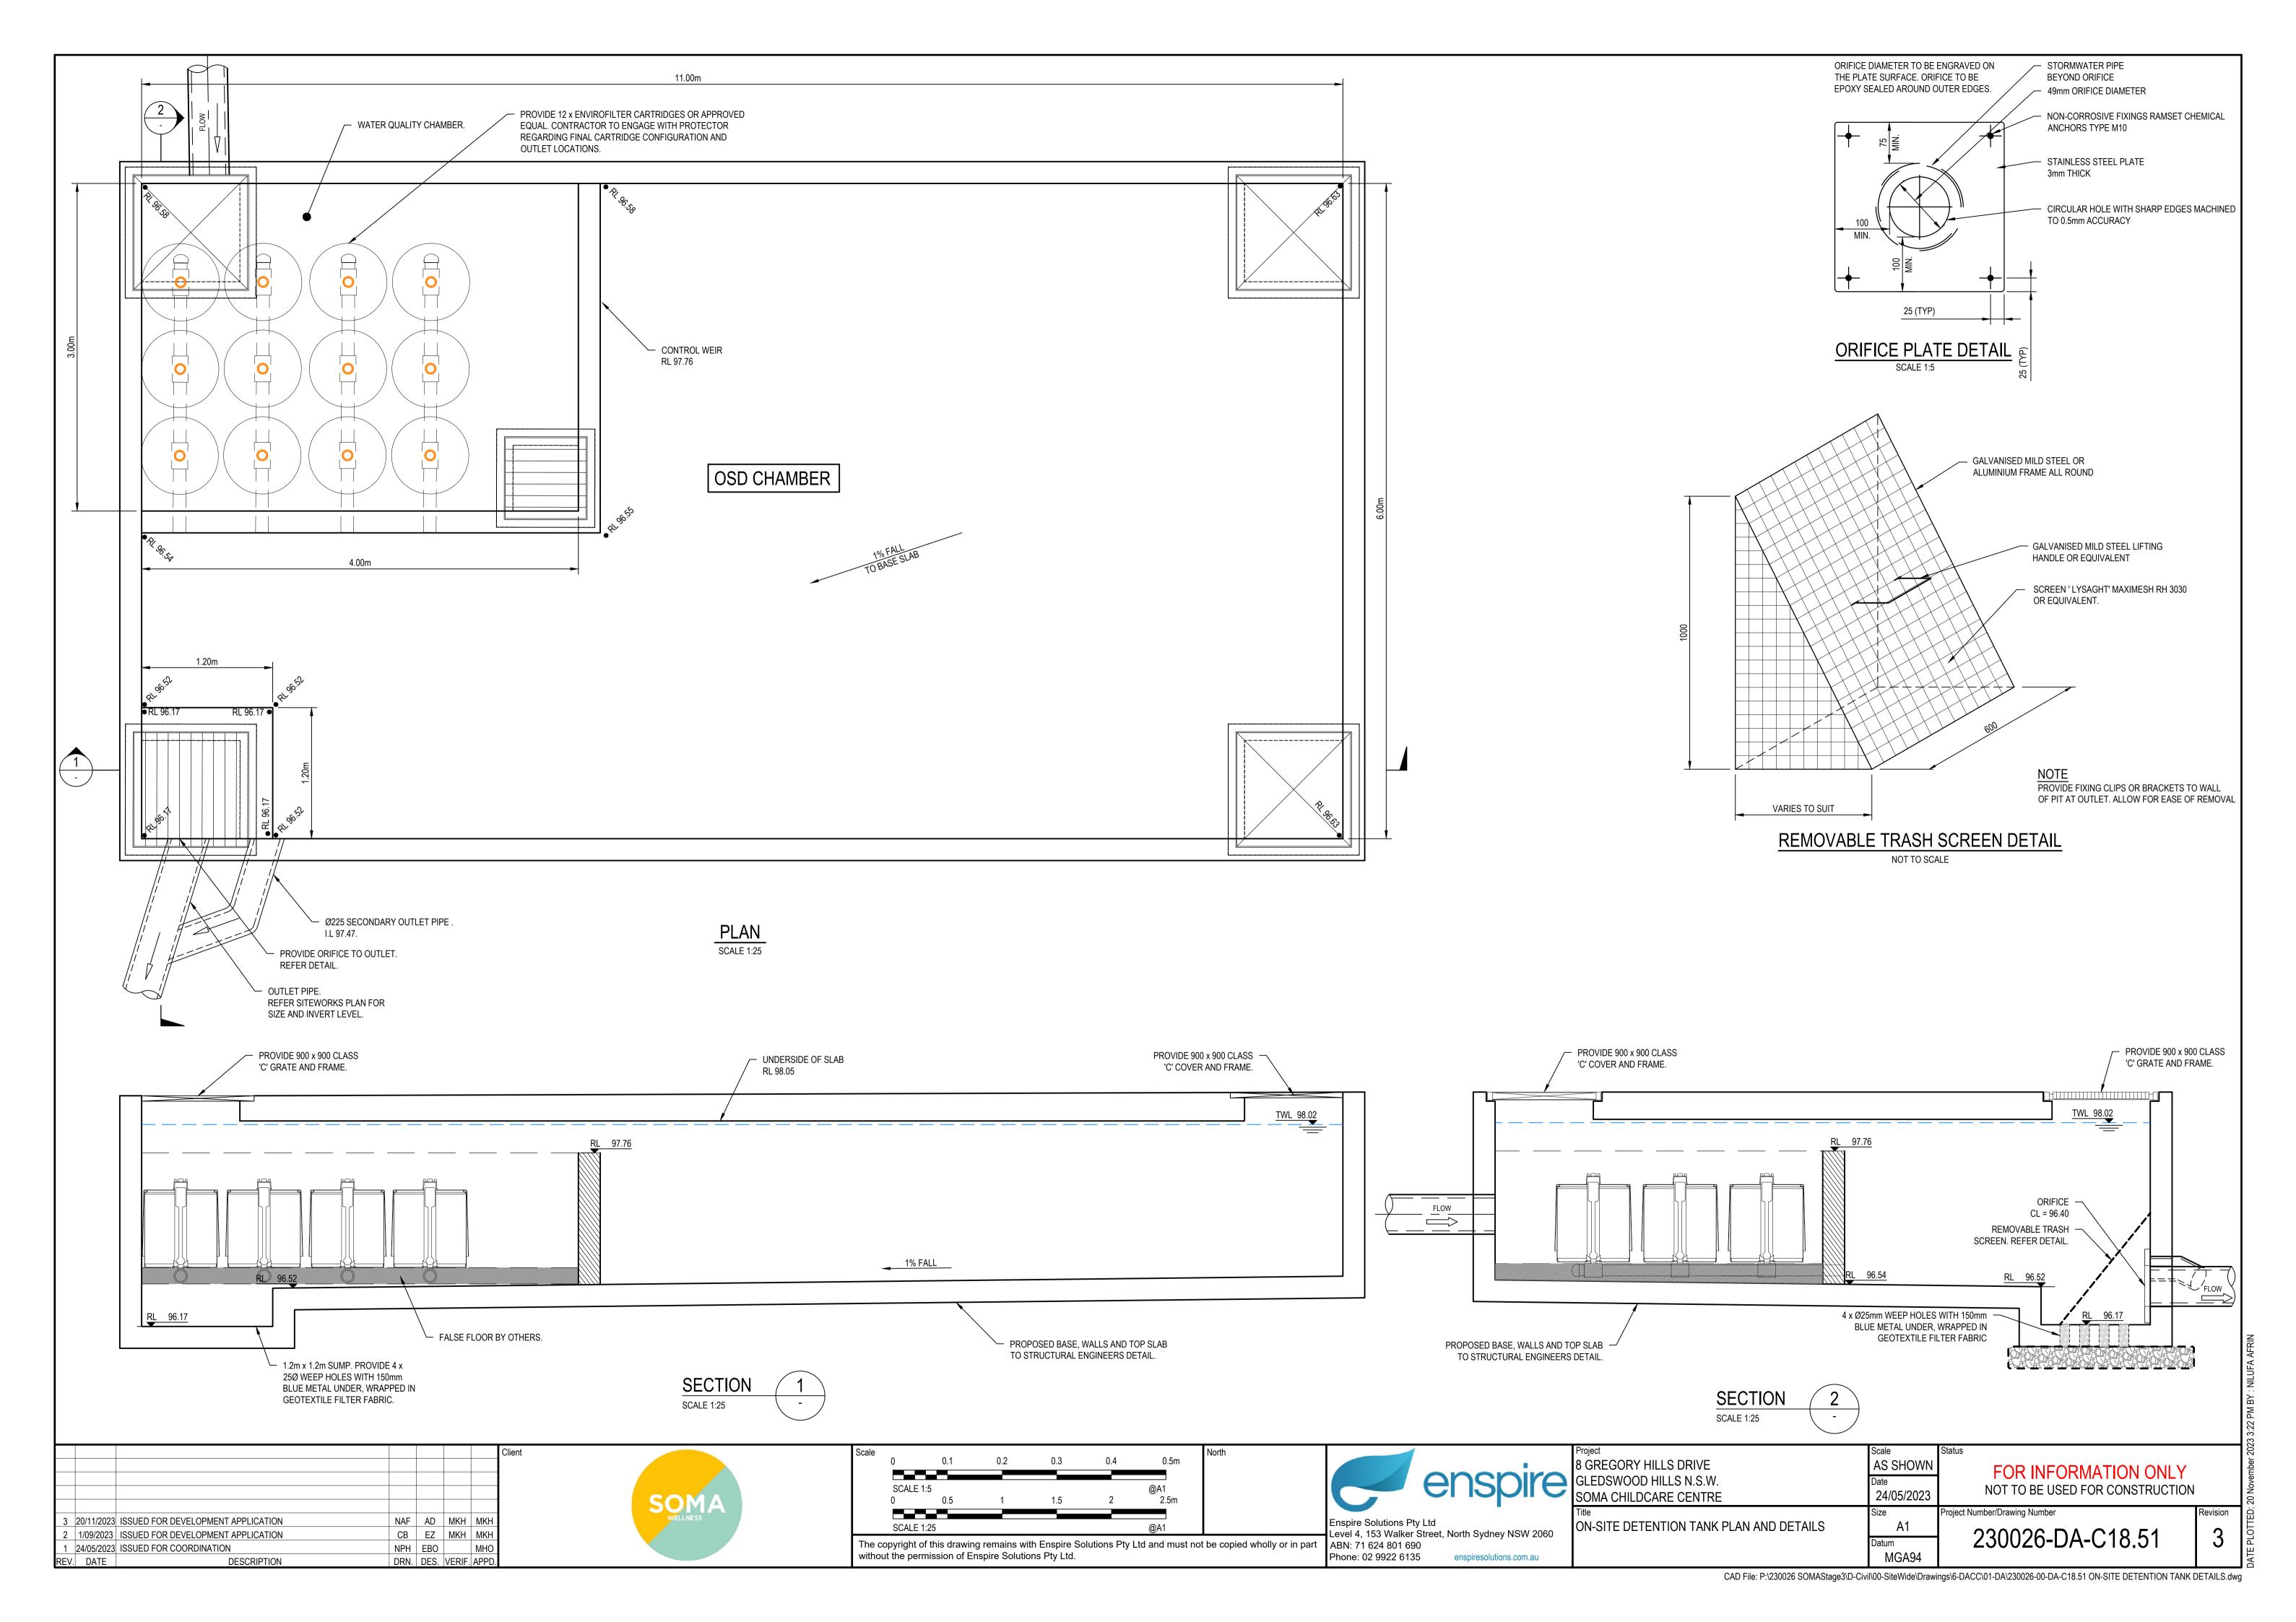

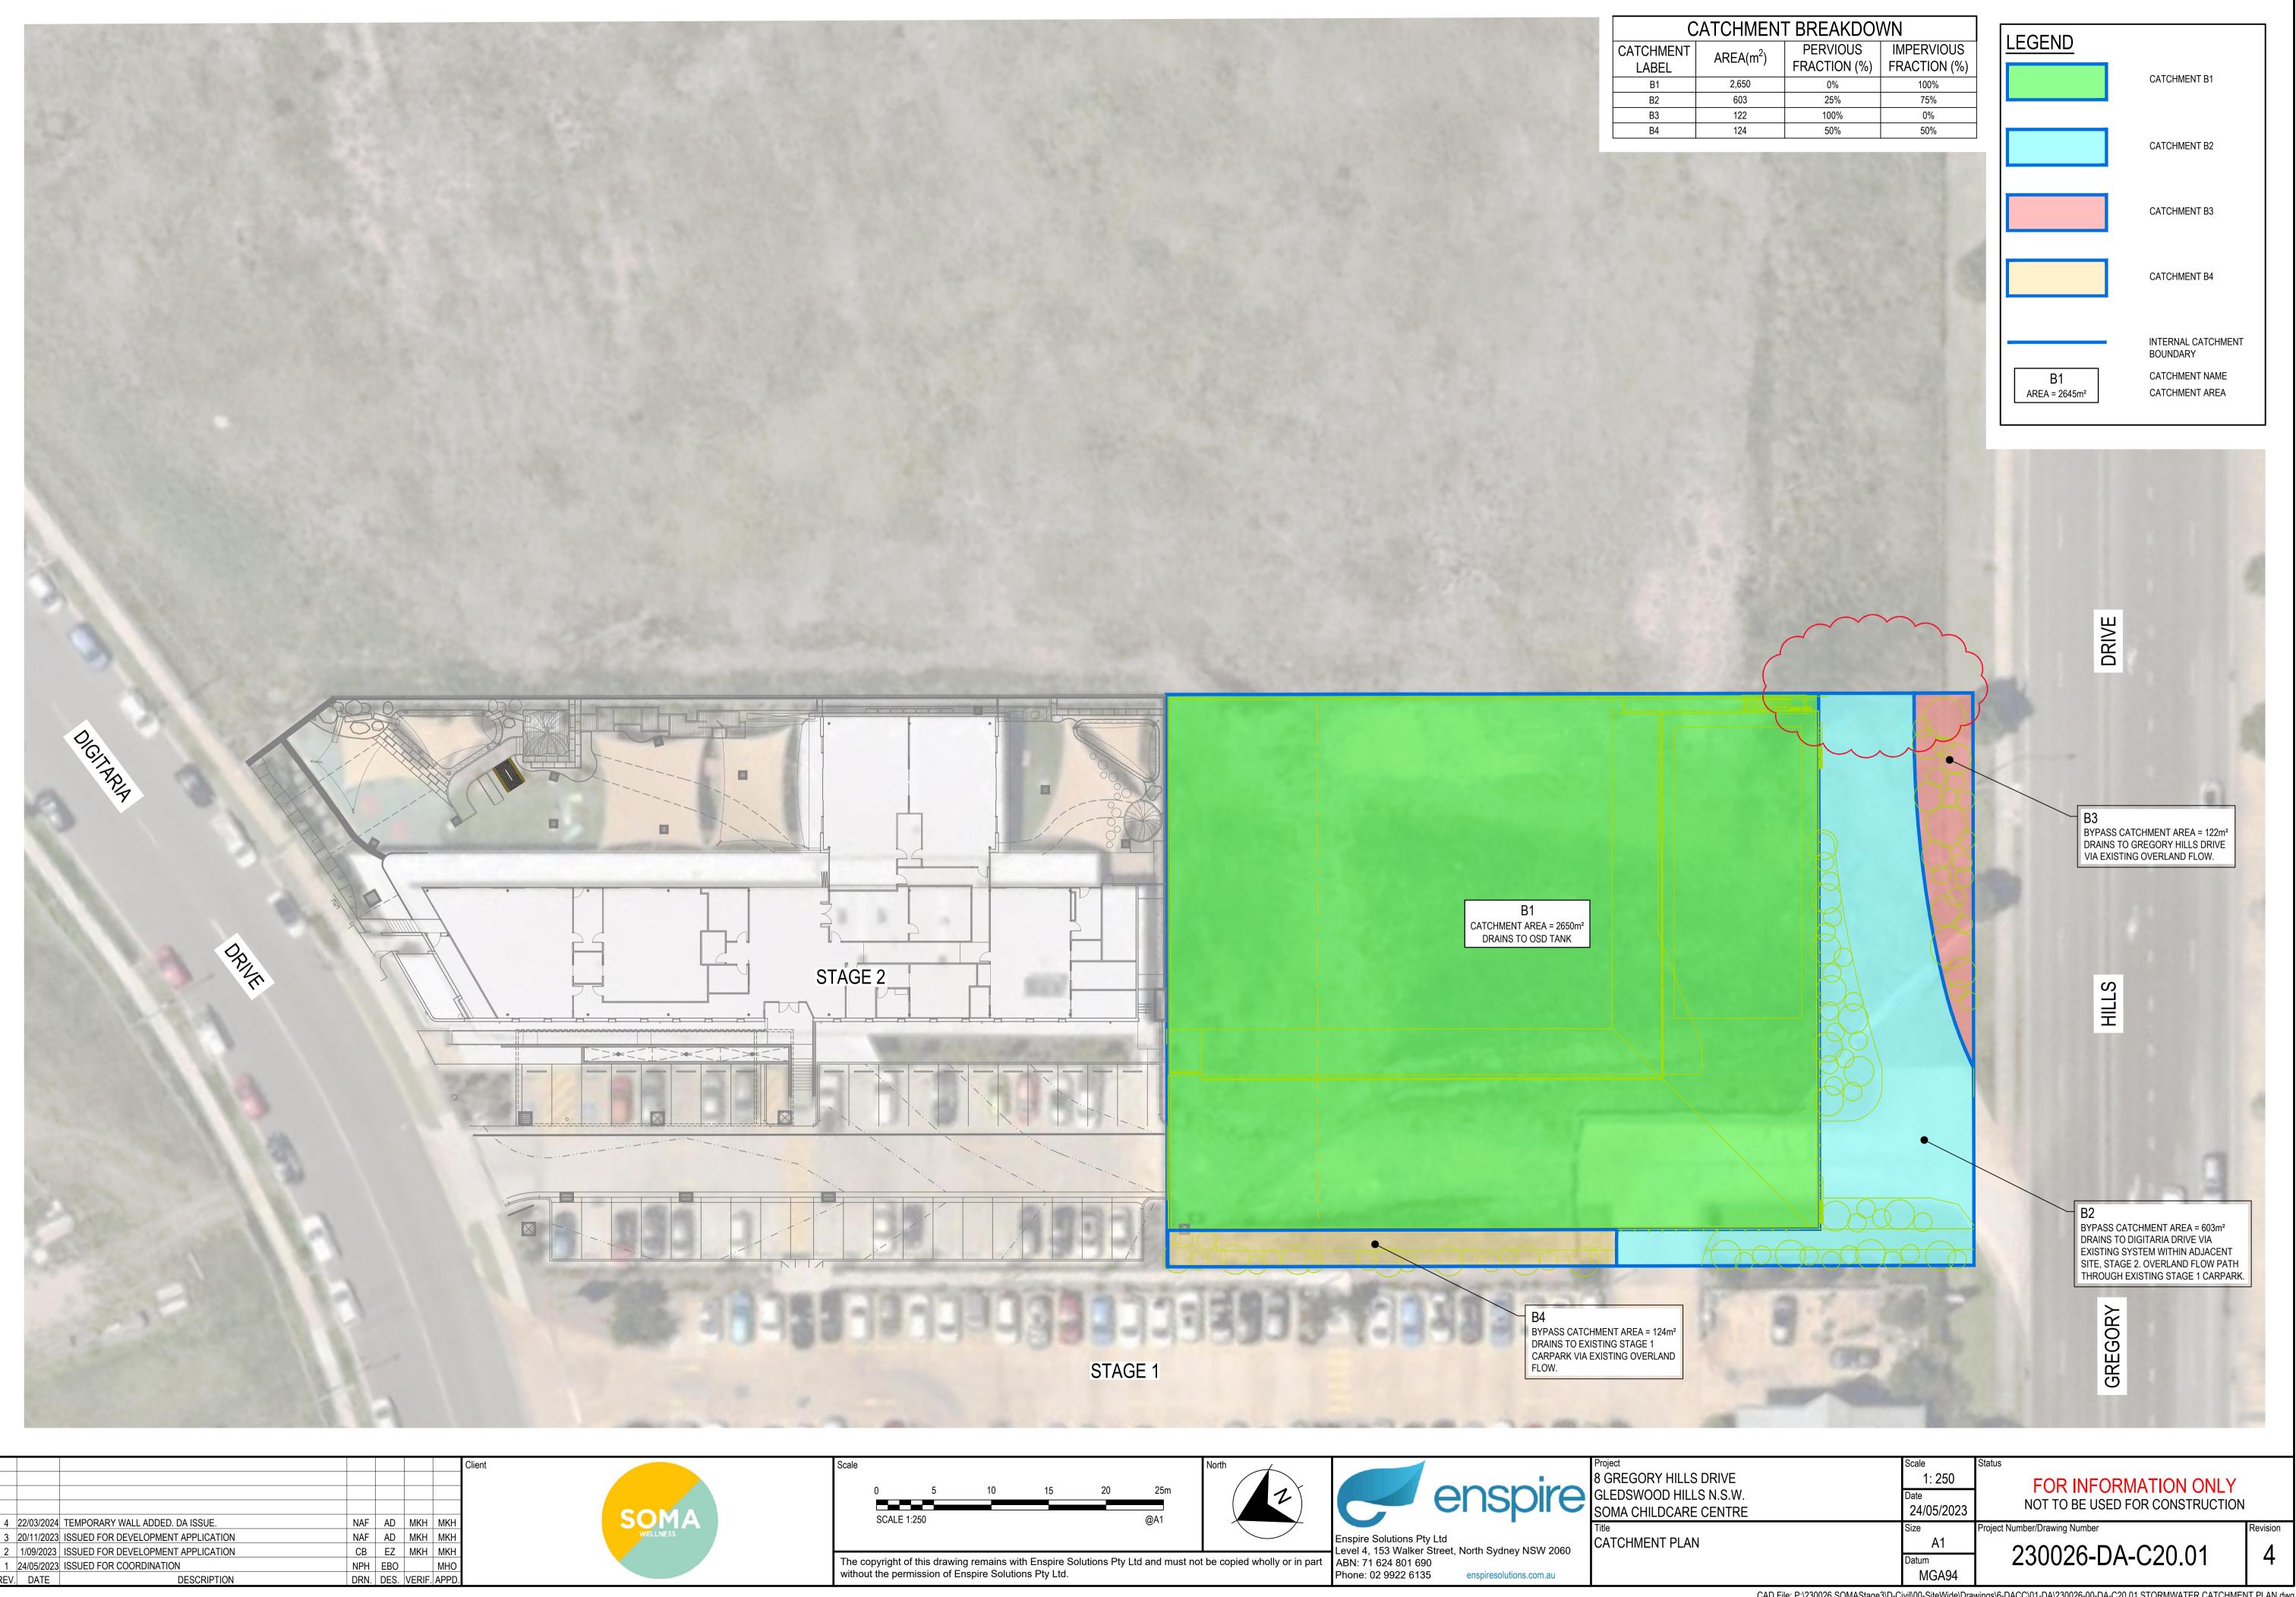TOW 103.900 m

TOW 102.100 m



GFL

98400 Piles to socket into rock

SOMA Stage 3



Digitaria Dr, Gledswood Hills

Mammoth